JONES COUNTY BOARD OF ADJUSTMENT

AGENDA

TUESDAY, OCTOBER 21 4:00 p.m. COMMUNITY ROOM, JONES COUNTY COURTHOUSE

4:00 p.m.

- Call meeting to order, approve agenda, and September 16, 2025 meeting minutes.
- Introduction of new member, Sarah Tate
- Annaul appointments and administrative rules

Public Hearing for property owners Mark, Jason, Deanne, and Jamie Hasler, and applicant AMG Technology Investment Group, dba Nextlink who have applied for a special permitted use permit for property of 9.75 acres

 located in the A-Agricultural Zoning District, described as N 1/4 NE 1/4 SW 1/4 of Section 01 of Lovell Township, generally located at 24491 135th Ave., Monticello, IA. More specifically, the application is to request new communications tower.

Action for property owners Mark, Jason, Deanne, and Jamie Hasler, and applicant AMG Technology Investment Group, dba Nextlink who have applied for a special permitted use permit for property of

- 9.75 acres located in the A-Agricultural Zoning District, described as N 1/4 NE 1/4 SW 1/4 of Section 01 of Lovell Township, generally located at 24491 135th Ave., Monticello, IA. More specifically, the application is to request new communications tower.
- Next meeting, if needed is November 18, 2025. Application deadline is Wednesday October 29, 2025.

Jones County Board of Adjustment

September 16, 2025, at 4:00 p.m.

Meeting Minutes

Members present:

John Hinz

Roger Kistler

Kathy McDonell

Members Absent:

Sarah Tate

Stan Reiter

Staff present:

Whitney Amos – Land Use Administrator

Visitors present:

Hinz called the meeting to order at 4:00 p.m.

Motion by Kistler was seconded by McDonell to approve the agenda. All Aye. Motion Carried.

Motion by McDonell seconded by Kistler to approve the meeting minutes for the March 18th meeting.

Motion by Kistler seconded by McDonell to open the public hearing at 4:03 p.m. for Property Owners Joseph Netolicky and Linda Willard who have applied for a variance for property of 6.30 acres located in the A-Agricultural Zoning District, described as part of the SW ¼ NE ¼ of Section 23 of Rome Township, generally located at 14378 35th St., Olin, IA. More specifically the variance is to request the reestablishment of residential use after more than one year has passed.

Amos noted that the Board received the copies of the application, aerial map, and written report. The owner & applicant also received a copy of the written report as required. Amos noted that the adjacent landowners certified letters were received. There was one written comment from a concerned adjacent property owner.

Motion by Kistler seconded by McDonell to close the public hearing at 4:09p.m. All aye. Motion carried.

There was much discussion by the Board questioning if the applicant has proven in the application that the three-part standard has been met. Since the applicants were not in attendance and unable to answer questions by the Board, the Board solely went off the application.

Motion by McDonell seconded by Kistler to deny the variance application for Owners Joseph Netolicky & Linda Willard due to lack of meeting the three part standard.

Roll call vote:

John Hinz-Roger Kistler-Kathy McDonell-

All aye. Motion carried.

The next regular scheduled meeting is October 21, 2025, with the application deadline being Wednesday October 1, 2025.

Motion by Kistler seconded by McDonell to adjourn at 4:28p.m. All aye. Motion carried.

BOARD OF ADJUSTMENT ADMINISTRATIVE RULES JONES COUNTY Adopted October 2025

In compliance with Iowa Code, Section 335.12 and the Jones County Zoning Ordinance, Title VI - Property & Land Use, the following rules and procedures are hereby adopted by the Jones County Board of Adjustment.

MEMBERSHIP

The Board shall consist of five (5) members appointed by the Board of Supervisors. The members shall reside within Jones County and all the members shall reside outside the corporate limits of any city. Each member shall be appointed for a term of five (5) years, except that with the initial board one (1) member shall be appointed for a term of five (5) years, one (1) member for a term of four (4) years, one (1) member for a term of three (3) years, one (1) member for a term of two (2) years, and one (1) member for a term of one (1) year. Members shall be removable for cause by the Board of Supervisors upon written charges and following public hearing. Vacancies shall be filled for the unexpired term of any member whose term becomes vacant.

OFFICERS

The Board of Adjustment shall select a chairperson at the first regular meeting in July to serve for a period of one (1) year (July 1-June 30). In his or her absence, an acting chairperson will be designated by the other members.

DUTIES

The chairperson, or in his absence, the acting chairperson, will preside at all meetings, appoint committees, administer oaths, compel the attendance of witnesses and perform such other duties as may be ordered by the Board.

OFFICE OF THE BOARD OF ADJUSTMENT

The Jones County Land Use Office is designated as the office of the Board of Adjustment. The Land Use Administrator shall be responsible for the secretary's duties; record and maintain minutes of the meetings, ensure that the minutes are adopted and perform such other duties as the board may determine.

MEETINGS

The Board shall determine regular meeting dates. The chairperson, secretary or applicant may request special meetings. All meetings of the Board of Adjustment shall be open to the public. The secretary shall keep and file records of the public hearings and other official actions. The secretary will provide the Board notice of the special meeting, purpose and time 48 hours in advance. If the special meeting is at the request of the applicant, costs of the special meeting will be assessed to the applicant.

QUORUM

A quorum of the board shall consist of 3 members. A quorum may be formed if one member of the three-person quorum is participating by teleconference. Without a quorum, no business will be transacted and no official action on any matter will take place.

PUBLIC NOTICE

On receipt of the application and filing fee, the Land Use Administrator shall place the application on the next regular Board of Adjustment meeting agenda and publish the public hearing notice including time and place at least five (5) days prior to the hearing, but no longer than twenty (20) days in the officially designated newspapers of the County. In addition, certified mailings shall be sent to all adjoining property owners with the time and place of the hearing.

ORDER OF BUSINESS

Call to order Approval of agenda Approval of minutes of previous meeting Reports of officers, committees, staff Unfinished business

New Business: Appeals and applications on the agenda

Time open for citizens wishing to address the Board on matters not on the established agenda

Any other discussion or announcements Notice of next meeting Adjourn

ORDER OF PUBLIC HEARING

Report by the Land Use staff
Appellants or applicants side of the case
Observer comments/case
Comment by Land Use staff
Appellant's rebuttal
Action by Board

CITIZEN PARTICIPATION

Persons other than Board members shall be permitted to address the Board on specific agenda items.

A citizen addressing the Board shall state his name and address.

Citizens shall be limited to three minutes speaking time per item unless additional time is granted by the presiding officer. Total citizen input on any subject under Board consideration shall be limited to a fixed period determined by the presiding officer.

Citizen comments must be directed to the subject under consideration. The presiding officer shall rule on the relevance of citizen comments. Citizens making personal, impertinent or slanderous remarks shall be barred by the presiding officer from further comment before the board.

The Board may, in its discretion, allow citizens who wish to raise a matter not on the agenda to address the Board at the end of the regular agenda

MOTIONS

Motions may be made by anyone on the Board except the presiding officer. The administrator shall restate the motion before a vote is taken.

DISCUSSION

A board member shall speak only after being recognized by the presiding officer. A member recognized for a specific purpose shall limit remarks to that purpose. A member, after being recognized, shall not be interrupted except by the presiding officer.

The presiding officer may enter into any discussion.

Each board member will limit his or hers remarks to a reasonable length.

The presiding officer has the right to close debate and speak last on any item.

Discussion may be closed on any item at any time by the presiding officer with concurrence of the majority of the Board.

Voting shall be by roll call and shall be recorded by aye or nay. Every member of the Board, including the presiding officer, is required to vote on each motion. A member shall abstain if he believes there is a conflict of interest, particularly if the conflict is of a financial nature.

Roberts Rules of Order, Revised, shall govern all Board meetings in all cases where these rules do not provide the procedures to be followed.

POWERS OF THE BOARD OF ADJUSTMENT

The Board will hear:

Appeals from any decision involving an alleged error in any order, requirement, decision or determination made by the Land Use Administrator in the enforcement of the Jones County Zoning Ordinance.

Authorize in special use cases and variances from the terms of this Ordinance, as will not be contrary to the public interest, where owing to special conditions a literal enforcement of the provision of the ordinance will result in unnecessary hardship, and so that the spirit of the ordinance shall be observed, and substantial justice is done.

VOTE REQUIRED

The concurring vote of three members of the Board of Adjustment shall be necessary to reverse any order, requirement, decisions, or determination of the Land Use Administrator, or to decide in favor of the applicant on any matter upon which it is required to pass under this Ordinance, or to affect any variance of this Ordinance.

APPLICATION FEE

The Board of Supervisors will set a filing fee which the Land Use Office will collect when the application is filed. The fees are payable to Jones County, Iowa, and are not refundable. The Land Use Administrator shall not take any action upon the application until the filing fee has been collected in full.

FEES FOR SPECIAL MEETINGS

The Board of Supervisors will determine the fee to hold any special meetings, when the special meeting was called in order to accommodate the schedule and any deadlines of the applicant.

ETHICS

Board members are expected to attend all regular and special meetings of the Board. If a member has a valid reason for nonattendance, the member shall notify the Land Use Administrator before the meeting.

Each member of the Board has an affirmative ethical duty to recuse themselves from hearing any matter before the Board in which financial, familial, intimate social interests, or public statements would call into question their ability to be impartial in the minds of a substantial portion of the general public; or in which a vote against the interests of one's family or close associates would likely cause significant tensions in those ongoing relationships.

Each member of the Board has an ethical duty to avoid obtaining, outside of the public hearing, alleged facts about, or opinions about, the merits of an application before the Board. Each case must be decided only on the basis of the evidence placed on the record in a public hearing of a matter before the Board. If a member of the public approaches a Board member, outside of the public hearing process, wanting to talk about a matter scheduled to be heard by the Board, the Board member should politely decline to discuss the matter.

Each member of the Board has an ethical duty to avoid saying anything in public for or against the merits of any matter before the Board, or any party involved in a matter before the Board, prior to the opening of the hearing on the case.

Members of the Board have a duty to scrupulously avoid involvements with parties to applications which might call into question their impartiality. For example, gifts or gratuities from a "grateful" applicant or member of the public after a hearing in which the Board member voted in favor of or against the party should not be accepted.

The Board will <u>not</u> consider a request (informal or not) for advice on theoretical or actual situations which potentially may later come before the Board as an appeal or application.

REVIEW BY BOARD OF ADJUSTMENT

The Board of Adjustment will review the application and report at the public hearing. If the land use change signs were not visible during site inspection, the request maybe tabled. It is also a recommendation by the Board of Supervisors that members of the Board of Adjustment review the properties on the agenda. At the said public hearing, the Board of Adjustment shall also receive comments from the applicant and the public at large. The Board of Adjustment shall then render its decision to approve the application in full, approve the application subject to modifications, table the application, request a review by the Board of Supervisors, or deny the application.

WRITTEN FINDINGS

The Board of Adjustment shall issue its decision in writing specifying the reasons for its decision. Whenever the Board of Adjustment approves or denies an application in full, or as modified, the decision shall also set out in detail the exact nature of the exception or variance granted or denied including any specific restrictions to be placed on the variance or the reasoning for the denial. The Land Use Administrator shall mail a copy of the decision to the applicant.

PERMIT

The Land Use Administrator shall issue a permit to any applicant who is granted an exception or variance by the Board of Adjustment. The permit shall describe the property subject to the exception or variance and shall also specify the exact nature of the exception or variance granted. No development or construction may be initiated on the property until the variance permit is issued. The permit shall become null and void one (1) year after the date on which it is issued unless the approved use is commenced within that same one (1) year time period.

REVIEW BY BOARD OF SUPERVISORS

The Board of Adjustment may table any variance application in order to request review by the Board of Supervisors. The Board of Supervisors' review shall include a majority vote and shall be sent back to the Board of Adjustment for their consideration in a final decision. The Board of Adjustment will have thirty (30) days from the date of the original public hearing to make a ruling.

APPEAL TO DISTRICT COURT

Pursuant to 2005 Iowa Code Section 335.18, any landowner, or other person aggrieved by a decision rendered under this Ordinance by the Board of Adjustment may file a petition with the District Court within thirty (30) days after the decision has been issued by the Board of Adjustment.

dopted by the Jones County Board of Adjustment on	
hairperson	

Jones County Land Use Rm 113 Courthouse, 500 W Main St.

Anamosa, Iowa 52205

Phone: 319-462-2282 Fax: 319-462-5815 Email: <u>landuse@jonescountyiowa.gov</u> Website: <u>www.jonescountyiowa.gov</u>



Special Permitted Use Application

	For Office	Use Only						
	☐ Appr	oved	☐ De	enied	Date	e:		
	Commen	ıts:				· · · · · · · · · · · · · · · · · · ·		
	Signatur	e of Jones	County	Land Use Adm	inistra	itor		
	The B	oard of Adjus	tment will	review the propo	sal and	deny or approv	/e .	
Fee:	\$250.00 (non-re	efundable) pa	yable to J	ones County, wit	h the co	mpleted applica	ation_	
Date A	Application Filed	d:						
	•			Own and Information	-4: - ·			
Name or	n property: Ma	rk Hasler, Jase	on Haslei	Owner Inform r, Deanne Hasler,		mie Hasler		
		House Number & Street: 23500 Hwy 151				Apartment/	Unit	
Address	to receive mail:	City: Monti	cello			State:	Zip Code:	52310
Phone:				E-mail Address:				
				Applicant Inform	nation			
Name: (If differe	ent from above.)	AMG Techno	ology Inv	estment Group,	dba Ne	xtlink - Megan	C	
		House Number of	House Number & Street: 95 Parker Oaks Ln.				Apartment/	Unit
Address	to receive mail:	City: Hudson	n Oaks			State: TX	Zip Code:	76087
Phone:				E-mail Address:				

			Parcel	Information	
Township	86	Section	01	Property Address	24491 135th Ave. Monticello, IA 52310
Zoning Dist	rict:			County Parcel ID(s	e), if known: 0201300003

Additional information regarding the parcel(s), if any:
01-86-03 N 1/4 NESW.
Acreage: 9.75 acres.
Proposed Use
Attach a site plan indicating the location of any existing, and proposed, buildings and driveways.
Attach a copy of the entrance access permit from the County Engineer, if any.
Attach a narrative providing the following information:
 Expected traffic volumes, including the impact on local roads and access to hard surface roads.
 Noise impact on surrounding property owners, residents, and livestock.
 Provisions for sanitary services (permanent and/or temporary waste disposal plans).
The narrative shall include any additional information required in the Zoning Ordinance for the specific permitted use
requested.
Additional information and regulations may be required of properties located in a Critical Resource Area Overlay (Section 9
of Article V).
Additional information may be requested by the County to assist the Board of Adjustment in considering the application.
☐ A and A2 - Agricultural District Special Permitted Uses Article V – Section 1. and 2. D.
Auxiliary dwelling units subject to Article XI.
☐ Bed and breakfast inns subject to Article VIII.
Churches or other places of worship, including parish houses and Sunday school facilities.
Commercial recreation uses subject to Article IX.
Communication towers subject to Article XIV.
Home-based Industries subject to Article VII.
☐ Kennels and Animal Shelter Requirements subject to Article XXI.
☐ Public and private stables.☐ Quarry and Extraction Uses subject to Article X.
☐ Quarry and Extraction oses subject to Article X. ☐ Seasonal dwelling units subject to Article XI.
☐ Seed, feed, biofuel plants, (biodiesel, ethanol) and other direct farm supply businesses.
☐ Wind Energy Conversion Systems (WECS) under 100 Kilowatts subject to Article XV.
☐ Wineries and other Value Added Agricultural Products.
Quarry and Extraction Uses subject to Article X.
□ B. Beridenskiel Birthick Ourseiel Berneitsted Here. Anticle V. Orestien O. B.
R - Residential District Special Permitted Uses Article V – Section 3. D. Animal shelters subject to Article XXI.
☐ Animal shellers subject to Article XXI. ☐ Auxiliary dwelling units subject to Article XI.
☐ Bed and breakfast inns subject to Article VIII.
☐ Churches or other places of worship, including parish houses and Sunday school facilities.
Home-based industries subject to Article VII.
Parks, playgrounds, golf courses (public and private), service organizations, and recreational uses.
Schools (public and private), educational institutions, preschools, and day care facilities.
☐ Wind Energy Conversion System (WECS) – Small subject to Article XV.
DMIL Decidential Manufactured Hausing District Special Demoited Hase Article V. Section 4. F.
RMH - Residential Manufactured Housing District Special Permitted Uses Article V – Section 4. E.
☐ Home-based industries subject to Article VII.
☐ C1 - Commercial District Special Permitted Uses Article V – Section 5. D.
☐ Bed and breakfast inns subject to Article VIII.
☐ Communication towers subject to Article XIV.
☐ Wind Energy Conversion Systems (WECS) – Small subject to Article XV.
☐ Wineries and other Value Added Agricultural Products.
☐ C2 - Highway Commercial District Special Permitted Uses Article V – Section 6. D.
☐ Bed and breakfast inns subject to Article VIII.
☐ Communication towers subject to Article XIV.
☐ Wind Energy Conversion Systems (WECS) – Small subject to Article XV.
☐ Wineries and other Value Added Agricultural Products.
Adult entertainment uses subject to Article XII.
☐ I1 - Industry District Special Permitted Uses Article V – Section 7. D.
Adult entertainment uses subject to Article XII.
Communication towers subject to Article XIV.
Quarry and Extraction Uses subject to Article X.
☐ Wind Energy Conversion Systems (WECS) – Small subject to Article XV.

The land parcel(s) must comply with the minimum lot area, front, rear, and side yard setbacks, and maximum height restrictions in the applicable district, as described in the Jones County Zoning Ordinance. The Jones County Zoning Ordinance is available in the office of the Jones County Auditor, or on-line at www.jonescountyjowa.gov.

The applicant is responsible for reviewing the provisions of the Jones County Zoning Ordinance prior to submitting this application.

DNR Storm Water Permits are required when development disturbs one acre or more of land. For more information, contact the Department of Natural Resources at (515) 725-8417 or contact Clark Ott at (563) 927-2640 and ask for storm water permit assistance.

Special Permitted Use applications are submitted to the Jones County Board of Adjustment for consideration and approval or denial. The Board of Adjustment may apply additional conditions for approval, as may be warranted to mitigate any deleterious effects of the proposed use. The decision of the Board of Adjustment may be appealed by filing a petition with the District Court within thirty (30) days after the decision has been issued by the Board of Adjustment.

This development is subject to, and shall be required, as a condition of final development approval, to comply with the Code of lowa and all Jones County ordinances, requirements, and standards that are in effect at the time of final development approval.

The undersigned applicant certifies under oath and under the penalties of perjury that the foregoing information is true and correct.

Megan Croop	09/03/2025
Applicant Signature	Date
Owner Signature (if different than above)	Date

QUESTIONS WHO TO CONTACT

Flood Plain Determination	Flood Plain Coordinator 319-462-4386 – Brenda Leonard
Access Permit for Drive	County Engineer 319-462-3785 – Derek Snead
911 Address	911 Coordinator 319-462-2735 - Gary Schwab 9-1 Mon - Wed
Well and Septic	Environmental Services 319-462-4715 – Paula Hart
Electrical Permits/Inspections	https://iowaelectrical.gov/ - ggrant@dps.state.ia.us Greg Grant 319-350-2404

TOWAIR Determination Results

A routine check of the coordinates, heights, and structure type you provided indicates that this structure does not require registration.

*** NOTICE ***

TOWAIR's findings are not definitive or binding, and we cannot guarantee that the data in TOWAIR are fully current and accurate. In some instances, TOWAIR may yield results that differ from application of the criteria set out in 47 C.F.R. Section 17.7 and 14 C.F.R. Section 77.13. A positive finding by TOWAIR recommending notification should be given considerable weight. On the other hand, a finding by TOWAIR recommending either for or against notification is not conclusive. It is the responsibility of each ASR participant to exercise due diligence to determine if it must coordinate its structure with the FAA. TOWAIR is only one tool designed to assist ASR participants in exercising this due diligence, and further investigation may be necessary to determine if FAA coordination is appropriate.

DETERMINATION Results

PASS SLOPE(100:1): NO FAA REQ-RWY MORE THAN 10499 MTRS & 7865.66 MTRS (7.86570 KM) AWAY

Туре	C/R	Latitude	Longitude	Name	Address	Lowest Elevation (m)	Runway Length (m)
AIRP	R	42-13- 8.00N	091-09- 27.00W	MONTICELLO RGNL	JONES MONTICELLO, IA	251.0	1341.0999999999999

PASS SLOPE(100:1): NO FAA REQ-RWY MORE THAN 10499 MTRS & 7231.68 MTRS (7.2317 KM) AWAY

Туре	C/R	Latitude	Longitude	Name	Address	Lowest Elevation (m)	Runway Length (m)
AIRP	R	42-13- 36.00N	091-10- 4.00W	MONTICELLO RGNL	JONES MONTICELLO, IA	251.0	1341.0999999999999

Your Specifications

NAD83 Coordinates

Measurements (Meters)	
Longitude	091-08-26.7 west
Latitude	42-17-19.0 north

Overall Structure Height (AGL)	45.7
Support Structure Height (AGL)	45.7
Site Elevation (AMSL)	305.4

Structure Type

LTOWER - Lattice Tower

Tower Construction Notifications

Notify Tribes and Historic Preservation Officers of your plans to build a tower.





AMG Technology Investment Group dba Nextlink

Narrative

Please see the following Narrative for your consideration of Nextlink's proposal for the installation of a new telecommunication tower.


- 1. Expected traffic volumes, including the impact on local roads and access to hard surface roads.
 - a. For a self support tower, we could expect work to take about 2 weeks, depending on weather. Maybe 4-5 trucks and 4-6 crewmen. For the pad, we would have 8-9 concrete trucks and 1 crane for the tower set up. After construction is completed, our electrical crew would go out there but that would be 1-2 times with a couple of annual check ups for the site.
- 2. Noise impact on surrounding property owners, residents, and livestock.
 - a. Once construction has been completed, there is very minimal noise impact to surrounding property owners, residents, and livestock.
- 3. Provisions for sanitary services (permanent and/or temporary waste disposal plans).
 - a. Our crew cleans up everything after a tower is stood. No waste/materials left behind.
- 4. FAA/FCC Requirements:
 - a. Please see attached document from FAA and FCC stating that registration of this tower falls within their guidelines and does not need to be registered.
- 5. Co-Location:
 - a. Co-location was not possible due to the closest tower is about 2 miles away from our current location and we were specific with this location to meet RDOF/CAF requirements. (Please see attached aerial view showing the closest tower.)

Megan Croop

Project Coordinator



855.NXT.LINK (855.698.5465) | D 682.789.6680

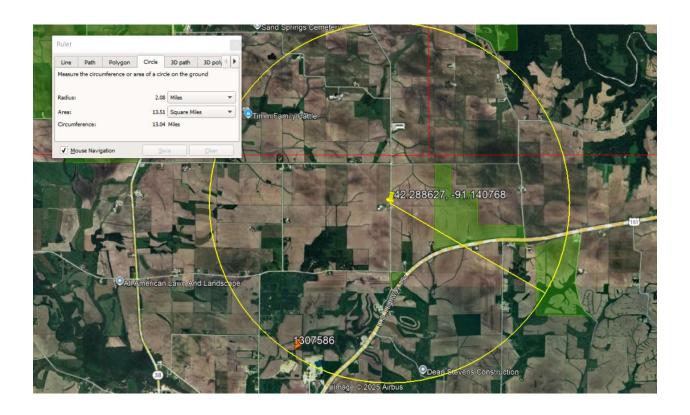



DIRECTIONS FROM MONTICELLO AIRPORT

(20373 IA-38, MONTICELLO, IA 52310)

SITE ID: **IA-HOPKINTON-SE-1**

SITE ADDRESS: 24491 135TH AVE.

THE SCOPE OF WORK CONSISTS OF:

(1) 15'-6" X 15'-6" CONCRETE PAD

NEW EQUIPMENT TO BE INSTALLED

(1) LTE CABINET

(1) CHAIN-LINK FENCE

(1) SELF-SUPPORT

(6) PANEL ANTENNAS

MONTICELLO, IA 52310

SCOPE OF WORK

SITE TYPE: SELF-SUPPORT

MEXTLINK

PLANS PREPARED FOR:

95 PARKER OAKS LN **HUDSON OAKS, TEXAS 76087**

ODISCOM, LLC 2600 S. SHORE BLVD. **SUITE 300** LEAGUE CITY, TX 77573 (469) 531-1176

www.odiscom.com


SITE ID:

IA-HOPKINTON-SE-1

SITE ADDRESS:

24491 135TH AVE. **MONTICELLO, IA 52310 JONES COUNTY**

	R	EVISION HISTORY	
REV	DATE	DESCRIPTION	BY
Α	08/28/25	PRELIMINARY	RS
0	08/29/25	FINAL	RS

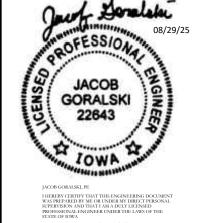

SHEET TITLE:

TITLE SHEET

SHEET NUMBER:

T-1

PROJECT INFORMATION

SITE ID: IA-HOPKINTON-SE-1

SITE ADRESS: 24491 135TH AVE. MONTICELLO, IA 52310

JURISDICTION: JONES COUNTY

APPLICANT: NEXTLINK 95 PARKER OAKS LN ADDRESS:

HUDSON OAKS, TEXAS 76087 SHANE MCINTYRE CONTACT:

SELF-SUPPORT

(712) 535-1406PHONE:

SMCINTYRE@TEAM.NXLINK.COM EMAIL:

SITE COORDINATES

SITE TYPE:

42.288627° LATITUDE: LONGITUDE: -91.140768°

GROUND ELEV. (AMSL): 1004

HASLER, MARK ETAL PROPERTY OWNER: ADDRESS: 23500 HWY 151 MONTICELLO, IA 52310

PHONE: 217-445-2421 CSHAVER@NHM88.COM EMAIL:

NOTE: DRAWING SCALES ARE FOR 11" X 17" SHEETS UNLESS OTHERWISE NOTED

APPLICABLE BUILDING CODES

ALL WORK AND MATERIALS SHALL BE PERFORMED AND INSTALLED IN ACCORDANCE WITH THE CURRENT EDITIONS OF THE FOLLOWING CODES AS ADOPTED BY THE LOCAL GOVERNING AUTHORITIES.

2015 INTERNATIONAL BUILDING CODE BUILDING CODE: ELECTRICAL CODE: 2020 NATIONAL ELECTRICAL CODE

- FACILITY IS UNMANNED AND NOT FOR HUMAN HABITATION.
- ADA ACCESS REQUIREMENTS ARE NOT REQUIRED
- THIS FACILITY DOES NOT REQUIRE POTABLE WATER AND WILL NOT PRODUCE ANY SEWAGE.

(2) DISH ANTENNAS, (4) ODUS (10) CATSE CABLES Hopkinton Langworth

MAP AND DIRECTIONS

HEAD NORTHWEST ON IA-38 N TOWARD SHOVER DR, TURN RIGHT TO MERGE ONTO US-151 N, TURN

LEFT ONTO 135TH AVE, TURN LEFT, DESTINATION WILL BE ON THE RIGHT AFTER 0.1 MI.

SUPPLIED MATERIAL ALL MATERIAL SHALL BE INSTALLED BY THE CONTRACTOR, UNLESS STATED OTHERWISE. **PROJECT TEAM**

PROJECT MANAGER

95 PARKER OAKS LN HUDSON OAKS, TEXAS 76087 CONTACT: SHANE MCINTYRE

PHONE: (712) 535-1406 EMAIL: SMCINTYRE@TEAM.NXLINK.COM

TITLE SHEET

DRAWING INDEX

CONTRACTOR SHALL FURNISH ALL MATERIAL WITH THE EXCEPTION OF NEXTLINK

ENGINEER

ODISCOM LLC

(817)456-2621


JACOB GORALSKI, PE

A-1	OVERALL SITE PLAN
A-2	ENLARGED SITE PLAN
A-3	SITE ELEVATION
A-4	ANTENNA & EQUIPMENT SUMMARY
D-1	GENERAL DETAILS
D-3	ANTENNA SPECIFICATIONS
D-4	ANTENNA SPECIFICATIONS
D-5	ANTENNA SPECIFICATIONS
E-1	ELECTRICAL PLAN
E-2	ELECTRICAL NOTES AND DETAILS
E-3	PANEL SCHEDULE & ONELINE

G-1GROUNDING PLAN

GROUNDING DETAILS

Know what's below Call before you dig.

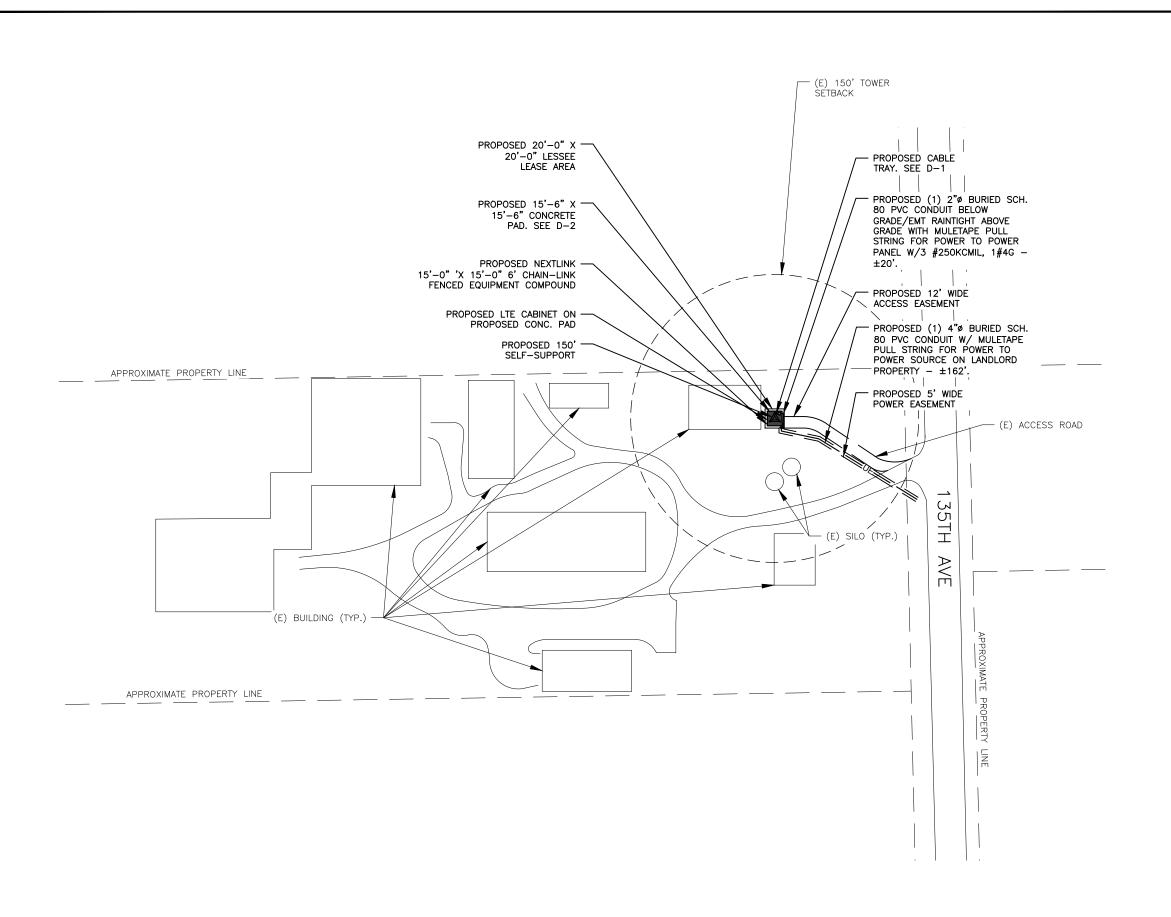





95 PARKER OAKS LN HUDSON OAKS, TEXAS 76087

PLANS PREPARED BY:

DISCOM

ODISCOM, LLC

2600 S. SHORE BLVD. SUITE 300 LEAGUE CITY, TX 77573

(469) 531-1176 www.odiscom.com

SITE ID:

IA-HOPKINTON-SE-1

SITE ADDRESS:

24491 135TH AVE.
MONTICELLO, IA 52310
JONES COUNTY

	REVISION HISTORY				
REV	DATE	DESCRIPTION	BY		
Α	08/28/25	PRELIMINARY	RS		
0	08/29/25	FINAL	RS		

STAN



JACOB GORALSKI, PE

I HEREBY CERTIFY THAT THIS ENGINEERING DOCUM
WAS PREPARED BY ME OR UNDER MY DIRECT PERSON
SUPERVISION AND THAT I AM A DULY LICENSED
PROFESSIONAL ENGINEER UNDER THE LAWS OF THE
STATE OF TOWA

SHEET TITL


OVERALL SITE PLAN

SHEET NUMBER:

A-1

SITE PLAN


SCALE: 1"=100'

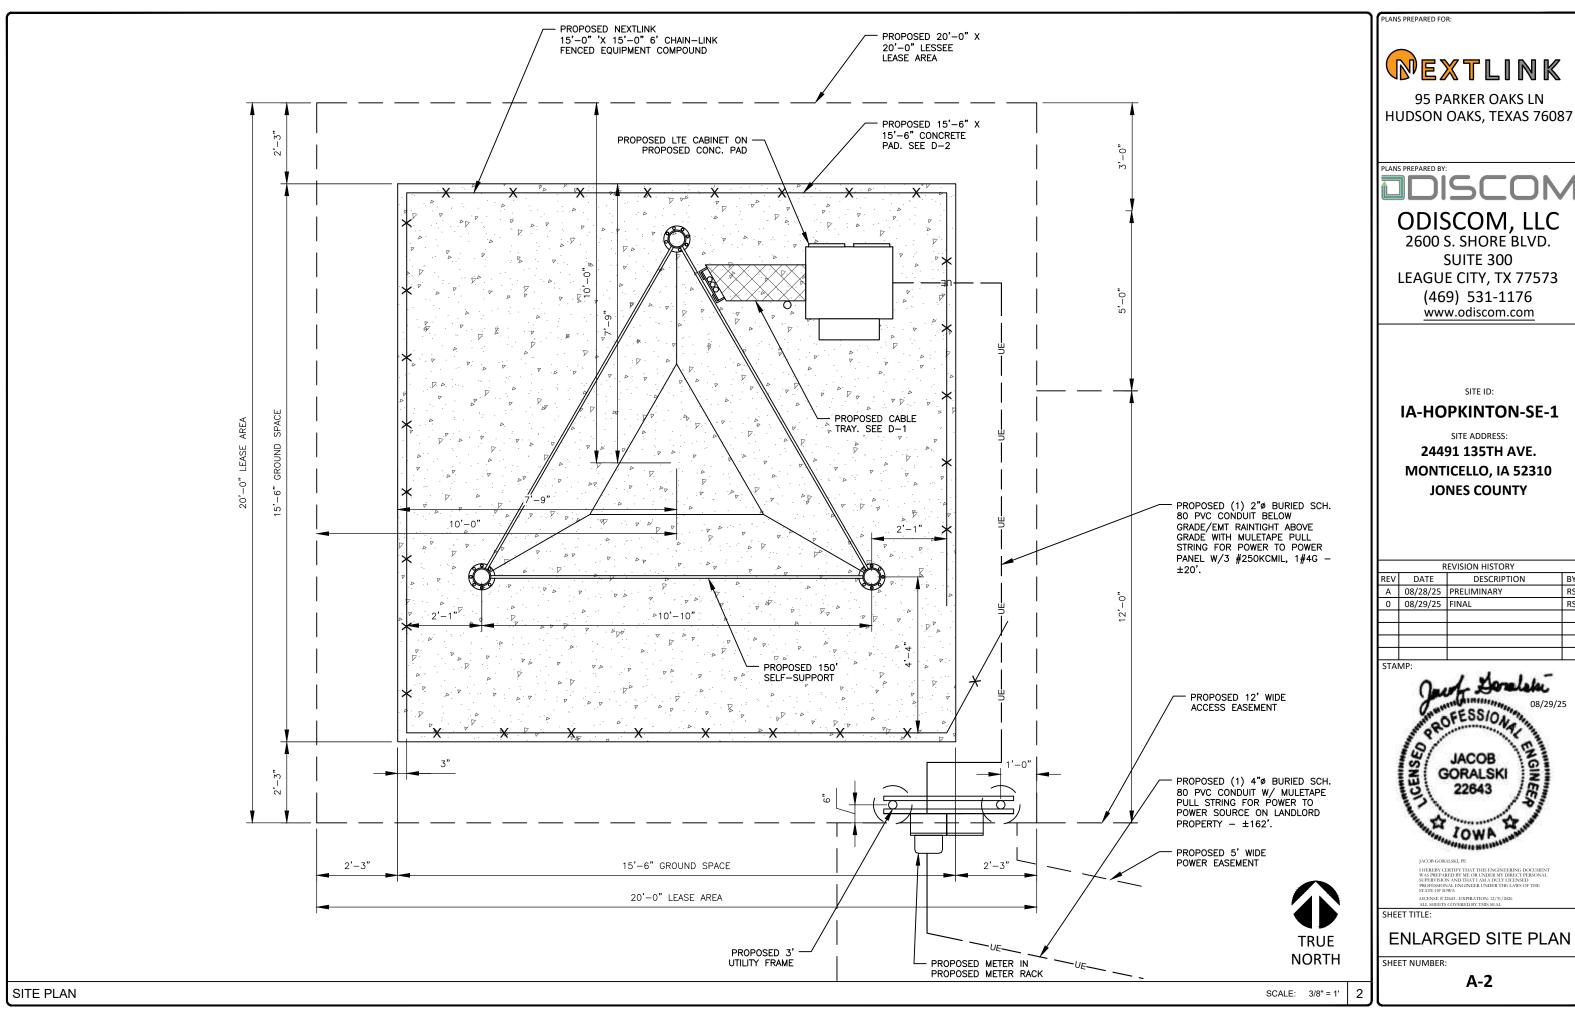

	REVISION HISTORY				
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Α	08/28/25	PRELIMINARY	RS		
0	08/29/25	FINAL	RS		



- 1. CALCULATIONS FOR THE STRUCTURE AND ANTENNA MOUNTS WERE PREPARED BE OTHERS AND THOSE CALCULATIONS CERTIFY THE CAPACITY OF THE STRUCTURE TO SUPPORT THE NEW EQUIPMENT
- 2. CABLES NOT SHOWN FOR CLARITY

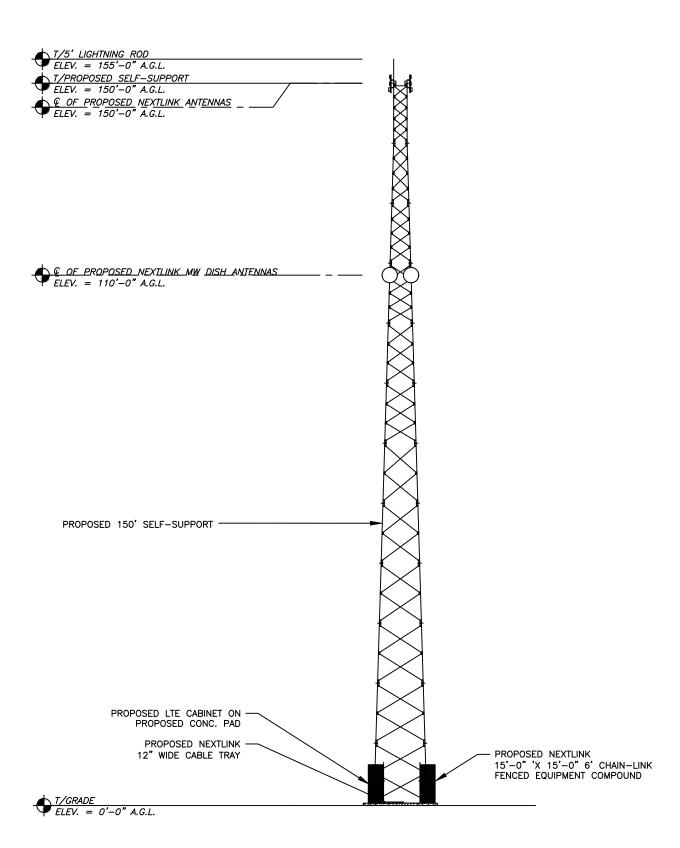



95 PARKER OAKS LN HUDSON OAKS, TEXAS 76087

PLANS PREPARED BY:



ODISCOM, LLC

2600 S. SHORE BLVD. SUITE 300 LEAGUE CITY, TX 77573

(469) 531-1176 www.odiscom.com

SITE ID:

IA-HOPKINTON-SE-1

SITE ADDRESS:

24491 135TH AVE.
MONTICELLO, IA 52310
JONES COUNTY

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JACOB GORALSKI, PE

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SHEET TITLE:

SITE ELEVATION

SHEET NUMBER:

A-3

SITE ELEVATION

SCALE: 1"=20'

ELEVATION (AGL, FT)	CARRIER	MOUNT	EQUIPMENT	FEEDLINES	LOCATION
150	NEXTLINK	TOWER LEG	(6) CAMBIUM PMP-3000	(6) 0.26" CAT5E	
110	(PROPOSED)	TOWER LEG	(2) RADIOWAVE HP2-11 (2) CAMBIUM PTP820S	(4) 0.26" CAT5E	OUTSIDE



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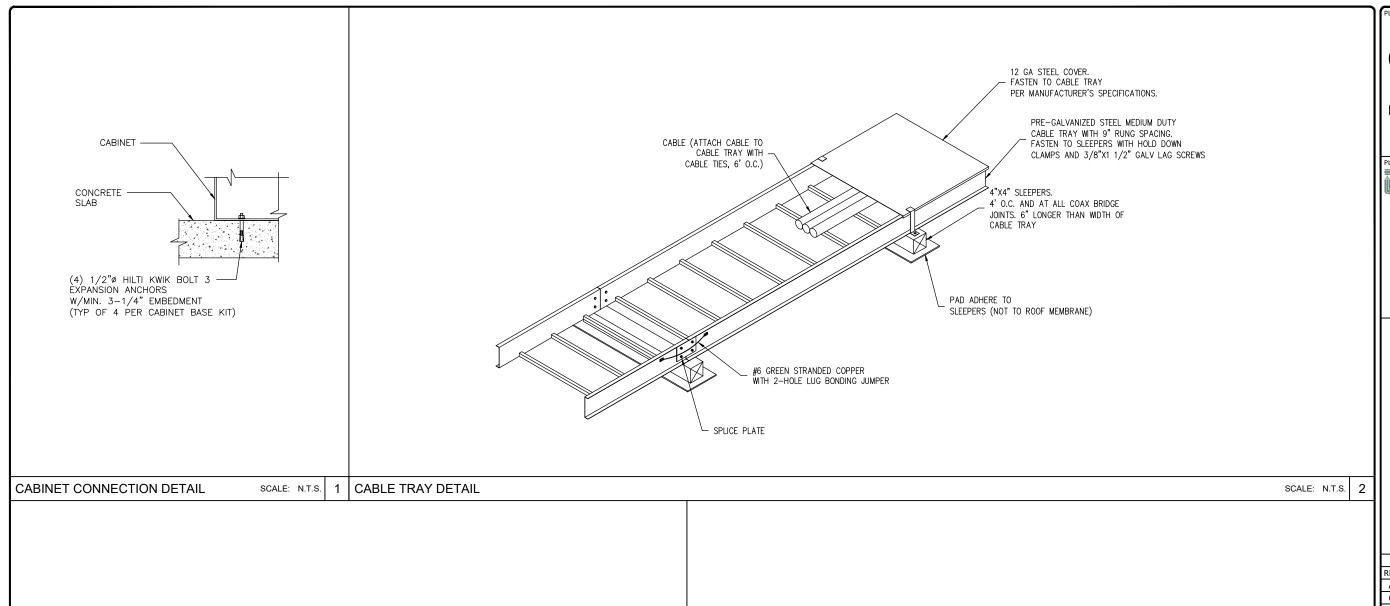
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SHEET TITLE:

ANTENNA & EQUIPMENT SUMMARY

A-4

ANTENNA AND EQUIPMENT SUMMARY





95 PARKER OAKS LN HUDSON OAKS, TEXAS 76087

PLANS PREPARED BY:

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STATE OF FOR

SHEET TITLE:

GENERAL DETAILS

SHEET NUMBER:

D-1

NOT USED SCALE: N.T.S. 3 NOT USED SCALE: N.T.S.



Cambium Networks has deployed more than five million radios around the world achieving unparalleled degrees of scalability. Continuing the tradition of designing and manufacturing industry leading antenna solutions, the ePMP 3000 4X4 sector antenna encompasses all the key differentiations of the Cambium Antenna line and adds 4X4 Multi User MIMO Capability. Designed to work in 5 GHz spectrum and 90 degree coverage, the antenna is an integral part of the ePMP 3000 Access Point and allows for Multi User MIMO Operation.

KEY DEPLOYMENT ADVANTAGES

- Frequency Re-use: Designed for ABAB channel re-use (two channels covering four sectors), the sector antenna has a minimum 30 dB front to back ratio over a wide rear facing anerture
- Channel Flexibility: Consistent gain from 4.9 to 6.0 GHz allows the operator to select a channel anywhere in the band and achieve the expected performance.
- Consistent Coverage: Excellent null fill capabilities of the antenna allow for broad geographical coverage within a sector even near the base of the tower and the edges of the sector.
- Designed for the Installer: Small, compact design, integrated ePMP radio mount and GPS antenna integration.
- Predictable Performance: The sector antenna is integrated into Cambium Networks LINKPlanner. The 3D model shows coverage at all elevations and across the azimuth.

KEY SPECIFICATIONS:

- 17 dBi gain
- 4.9 to 5.97 GHz spectrum
- 30 dBi front to back ratio
- IP 65 ruggedization

SP	ECI	FIC	CAT	101	VS


ePMP 3000 SECTOR ANTENNA				
Model Number	C050910D301A			
Frequency Range	4.9 GHz to 5.97 GHz			
Gain	17 dBi			
3 dB Beamwidth - Azimuth	70 degrees			
3 dB Beamwidth - Elevation	6 degrees			
Electrical Downtilt	-2 degrees			
Polarization	2X Horizontal, 2X Vertical			


ePMP™ 3000 Sector Antenna SPECIFICATION SHEET


ePMP 3000 SECTOR ANTENNA	
Model Number	C050910D301A
Port-to-Port Isolation	> 20 dB
Front-to-Back Ratio	30 dB
Maximum Input Power	5 W
Input Impedance	50 ohms
Mounting Connectors	4 x RP SMA
Mounting Hardware	Included for mounting to mast diameters 2" to 4" (5 cm to 10 cm) -10 to >5 degree till. Hardware included to connect ePMP access point to back of antenna body
Physical Dimensions	Antenna Body: 23.4" (H) x 9.6" (W) x 3.25" (D) (594 mm x 157 mm x 110 mm)
Weight	Antenna Body: 8.0 lbs, 3.7 kg w/ ePMP 3000 Access Point and Mounting Brackets: 13.8 lbs, 6.3 kg
Environmental	IP65
Radome Material	UV Protected ABS
Operating Temp	-40°C to 60°C (-40°F to 140°F)

ANTENNA PATTERNS


SPECIFICATIONS

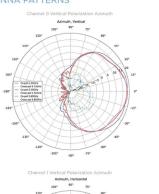


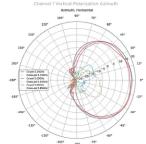

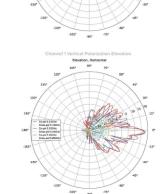



ANTENNA PATTERNS

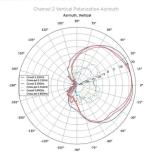

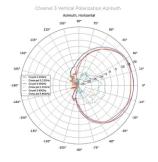

PMP™ 3000 Sector Antenna SPECIFICATION SHEET

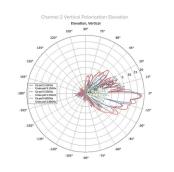

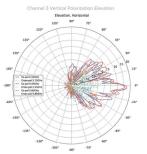

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SS ePMP** 3000 Sector Antenna 10032

PLANS PREPARED FOR:



95 PARKER OAKS LN HUDSON OAKS, TEXAS 76087

PLANS PREPARED BY:

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SHEET TITLE:

ANTENNA SPECIFICATIONS

I NUMBER:

D-2



HP2-11

0.6 M | 2 FT HIGH PERFORMANCE PARABOLIC REFLECTOR ANTENNA, SINGLE-POLARIZED, 10.7-11.7GHZ

The HP High Performance Series by RadioWaves offers a full line of high performance parabolic antennas engineered to provide ETSI class 2/3 radiation pattern performance as well as excellent gain. RadioWaves field-proven pre-assembled antennas and robust pole-mounts ensure "set and forget" installation with minimal post-installation maintenance. The included radome ensures robust and reliable performance under the most challenging conditions. If it's rugged, it must be RadioWaves!



FEATURES AND BENEFITS

- High Performance ETSI Class 2/3* Parabolic Antennas Excellent performance for a wide range of applications
- Fully Preassembled at the Factory Simplifies installation on site and guarantees "factory-tested" quality
- · Warranty Industry leading 7-year warranty

*ETSI Class depends on frequency band

SPECIFICATIONS

General

Antenna Type	High Performance Parabolic Reflector Antenna
Size, nominal	2 ft 0.6 m
Polarization	Single

Standard RF Connector Type	CPR90G
Standard RF Connector Suffix	RS (append suffix to model number)

Electrical

an INFINIT@ company

Operating Frequency Band	10.7 - 11.7 GHz
Half Power Beamwidth, Horizontal	3.4 degrees
Half Power Beamwidth, Vertical	3.4 degrees
Cross-Polarization Discrimination	30 dB
Front to Back Ratio (F/B)	60 dB

Gain, Low Frequency	34.2 dBi
Gain, Mid Frequency	34.5 dBi
Gain, High Frequency	34.8 dBi
VSWR	1.37:1
Return Loss	-16.1 dB



Mechanical

Fine Azimuth Adjustment	+/- 10 degrees
Fine Elevation Adjustment	+/- 30 degrees
Mounting Pipe Diameter, Min	2 inch 5.08 cm
Mounting Pipe Diameter, Max	4.5 inch 11.4 cm
Net Weight	27 lbs 12.3 kg
Wind Velocity Operational	90 mph 145 km/h
Wind Velocity Survival Rating	125 mph 201 km/h

Mechanical Configuration	HP2
Axial Force (FA)	202 lbs 899 N
Side Force (FS)	100 lbs 445 N
Twisting Moment (MT)	194 ft-lbs 263 Nm
Operating Temperature Range	-40 to +60 C
Max Pressure, PSIG, (if waveguide interface)	5

Regulatory Compliance

FCC	Part 101 Cat. B
Industry Canada Compliance	undeclared

ETSI	302217 R1 C2
RoHS-compliant	Yes

Shipping Information

Package Type	Cardboard
Gross Weight	48 lbs 28.7 kg

Dimensions, L x W x H	31 x 31 x 25in 79 x 79 x 64 cm		
Shipping Volume	13.9 cu ft 0.39 cu m		

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Contact Us: +1.978.459.8800 | radiowaves.com

*Additional OEM interfaces and adapters may be available. Contact RadioWaves for a complete and current list of available adapters.

PLANS PREPARED FOR:



95 PARKER OAKS LN HUDSON OAKS, TEXAS 76087

ODISCOM, LLC 2600 S. SHORE BLVD. SUITE 300 LEAGUE CITY, TX 77573 (469) 531-1176 www.odiscom.com

SITE ID:

IA-HOPKINTON-SE-1

SITE ADDRESS:

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0	08/29/25	FINAL	RS		

SHEET TITLE:

ANTENNA **SPECIFICATIONS**

SHEET NUMBER

D-3

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DATA SHEET

PTP 820C Licensed Microwave Radio

QUICK LOOK:

PTP 820C, an all Outdoor dual-core radio capable of 1024 QAM with ACM

- Support 6-38 GHz
- Support 1+0 to 4+0, 1+1/2+2, 2 x 1+0 **East-West configuration**
- Support Multi Band(With PTP 850E or PTP 820E)



Radio

6-38 GHz

1+0 to 4+0, 1+1/2+2, 2 x 1+0 East-West

Multi Band(With PTP 850E or PTP 820E)

Radio Features

Multi-Carrier Adaptive Bandwidth Control (up to 2+0)

Protection: 1+1/2+2 HSB, 1+1 HSB-SD

QPSK to 2048 QAM w/ACM

2x2 / 4x4 MIMO

Advanced Space Diversity (ASD)

Advanced Frequency Reuse (AFR)

Ethernet

Ethernet Interfaces

Traffic Interfaces - 1 x 10/100/1000Base-T (RJ-45) and 1x1000base-X (SFP) or 10/100/1000 Base-T (electrical SFP)

Management Interface - 1 x 10/100 Base-T (RJ-45)

Optical SFP Types - Optical 1000Base-LX (1310 nm) or SX (850nm)

Note: SFP devices must be of industrial grade (-40°C to +85°C)

Ethernet Features

MTU - 9600 Bytes

Quality of Service

Multiple Classification criteria (VLAN ID, p-bits, IPv4, DSCP, IPv6 TC, MPLS EXP)

8 priority queues

Deep buffering (configurable up to 64 Mbit per queue) WRED

P-bit marking/remarking

4K VLANs

VLAN add/remove/translate

Frame Cut Through - controlled latency and PDV for delay sensitive applications

Header De-Duplication – Capacity boosting by eliminating inefficiency in all layers (L2, MPLS, L3, L4, Tunneling - GTP for

Y.1731 Ethernet OAMY.1731 Ethernet Bandwidth Notification (ETH-BN)

Adaptive Bandwidth Notification (ABN)

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PTP 820C Licensed Microwave Radio

Management Protocols

SNMP

REST

SDN Support: NETCONF/YANG

Synchronization

Synchronization Distribution

Sync Distribution over any traffic interface (GE/FE)

Sync-E (ITU-T G.8261, G.8262)

SSM/ESMC Support for ring/mesh applications (ITU-T G.8264)

Sync-E Regenerator mode, providing PRC grade (ITU-T G.811) performance for smart pipe applications.

IEEE-1588

Optimized Transport for reduced PDV

IEEE-1588 TC

Security

AES 256-bit Encryption

Secured protocols (HTTPS, SNMPV3, SSH, SFTP)

Radius authentication and authorization

TACACS+ authentication and authorization (session-based)

Standard

MEF

Carrier Ethernet 2.0 (CE 2.0)

Supported Ethernet Standards

10/100/1000base-T/X (IEEE 802.3)

Ethernet VLANs (IEEE 802.3ac) Virtual LAN (VLAN, IEEE 802.1Q)

Class of service (IEEE 802.1p)

Provider bridges (Q-in-Q - IEEE 802.1ad)

Link aggregation (IEEE 802.3ad)

Auto MDI/MDIX for 1000baseT

RFC 1349: IPv4 TOS RFC 2474: IPv4 DSCP

RFC 2460: IPv6 Traffic Classes

Standards Compliance

EMC: EN 301 489-1, EN 301 489-4, Class B (Europe), FCC 47 CFR, part 15, class B (US), ICES-003, Class B (Canada), TEC/EMI/TEL-001/01, Class B (India)

Surge: EN61000-4-5, Class 4 (for PWR and ETH1/PoE ports)

Safety: EN 60950-1, IEC 60950-1, UL 60950-1, CSA-C22.2 No.60950-1, EN 60950-22, UL 60950-22, CSAC22.2.60950-22

Ingress Protection: IP66-compliant

Storage: ETSI EN 300 019-1-1 Class 1.2

Transportation: ETSI EN 300 019-1-2 Class 2.3

Technical

Mechanical Specifications

Dimensions: 230mm(H), 233mm(W), 98mm(D), 6kg;

9.05"(H), 9.07"(W), 3.86"(D), 12lbs.

Pole Diameter Range (for Remote Mount Installation)

8.89 cm - 11.43 cm; 3.5" - 4.5"

Environmental Specifications

-33°C to +55°C (-45°C to +60°C extended); -27°F to +131°F (-49°F to +140°F extended)

Power Input Specifications

Standard Input: -48 VDC

IDU DC Input range: -40 to -60 VDC

Power Consumption Specifications

Maximum Power Consumption (2+0 Operation) 6 GHz; 65W; 7/8 GHz: 75W; 11 GHz: 65W; 13-15 GHz: 55W; 18-24 GHz: 48W; 26-38

Maximum Power Consumption (1+0 Operation) -5.7-6 GHz: 40W; 7-8 GHz: 50W; 11 GHz: 53W; 13-15 GHz: 41W; 18-24 GHz: 39W; 26-38 GHz: 41W

PoE Injector Mechanical Specifications

Dimensions - 134mm(H), 190mm(W), 62mm(D), 1 kg; 5.28"(H), 7.48"(W), 2.44"(D), 2.2 lbs.

PoE Injector Environmental Specifications

33°C to +55°C (-45°C to +60°C extended); -27°F to +131°F (-49°F to +140°E extended)

PoE Injector Power Input Specifications

Standard Input: -48 or +24 VDC (Optional)

DC Input range: ±(18/40.5 to 60) VDC (+18VDC extended range is supported as part of the nominal +24VDC support)

PoE Injector Interfaces

GbE Data Port supporting 10/100/1000Base-T

Power-Over-Ethernet (PoE) Port

DC Power Port -40V to -60V (a PoE supporting two redundant

DC feeds each supporting ±(18-60)V is available)

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MEXTLINK

95 PARKER OAKS LN

HUDSON OAKS, TEXAS 76087

PLANS PREPARED FOR:

ODISCOM, LLC

2600 S. SHORE BLVD. **SUITE 300** LEAGUE CITY, TX 77573 (469) 531-1176 www.odiscom.com

SITE ID:

IA-HOPKINTON-SE-1

SITE ADDRESS:


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ANTENNA SPECIFICATIONS

SHEET NUMBER

D-4



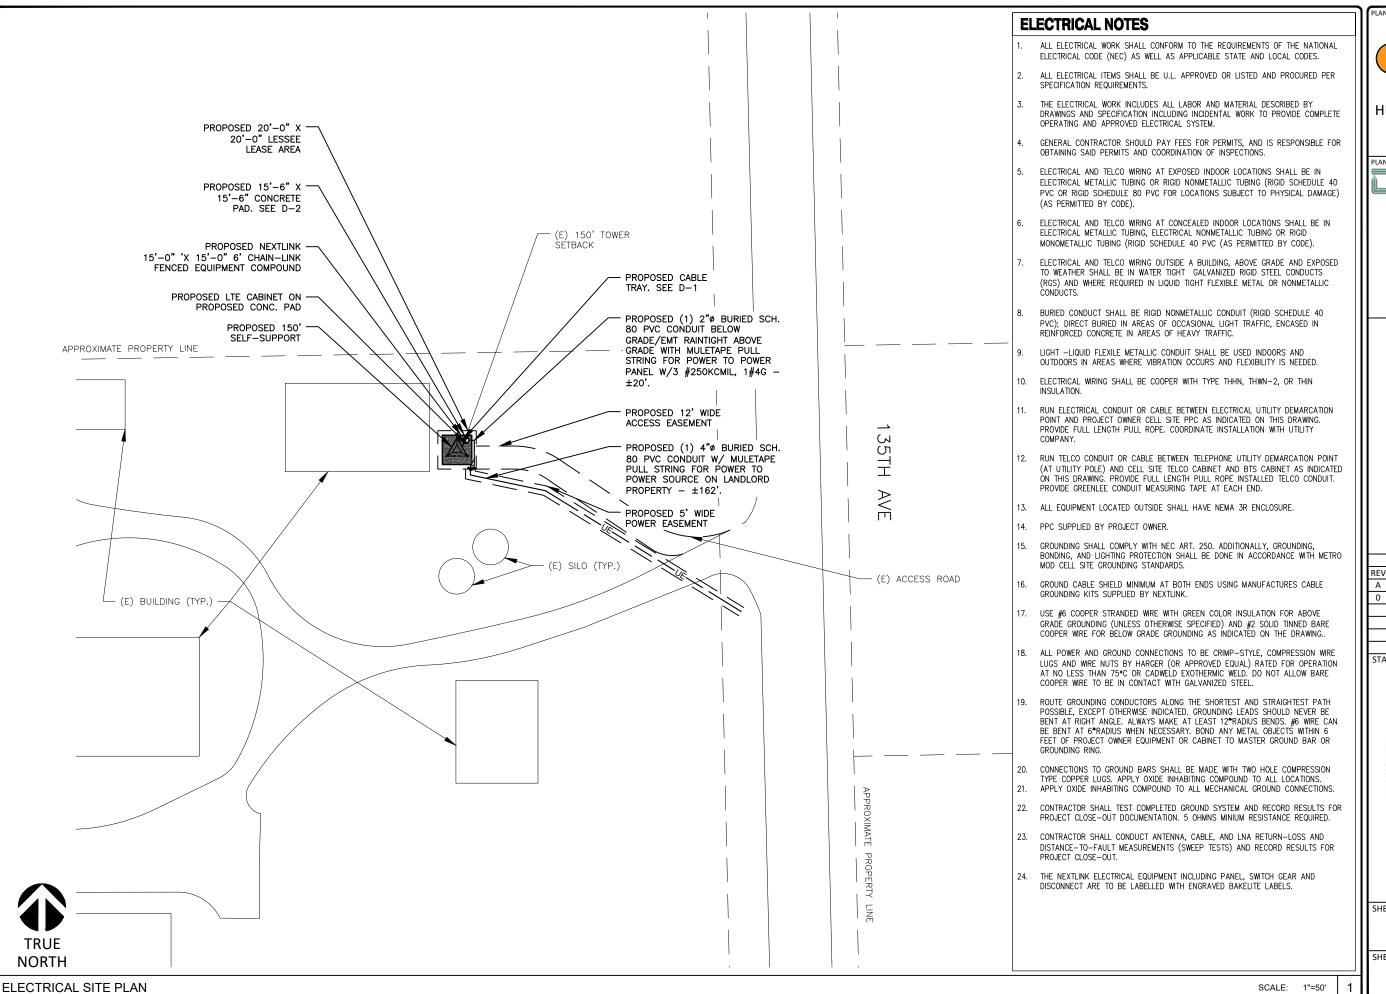

95 PARKER OAKS LN **HUDSON OAKS, TEXAS 76087**



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SUITE 300

LEAGUE CITY, TX 77573 (469) 531-1176

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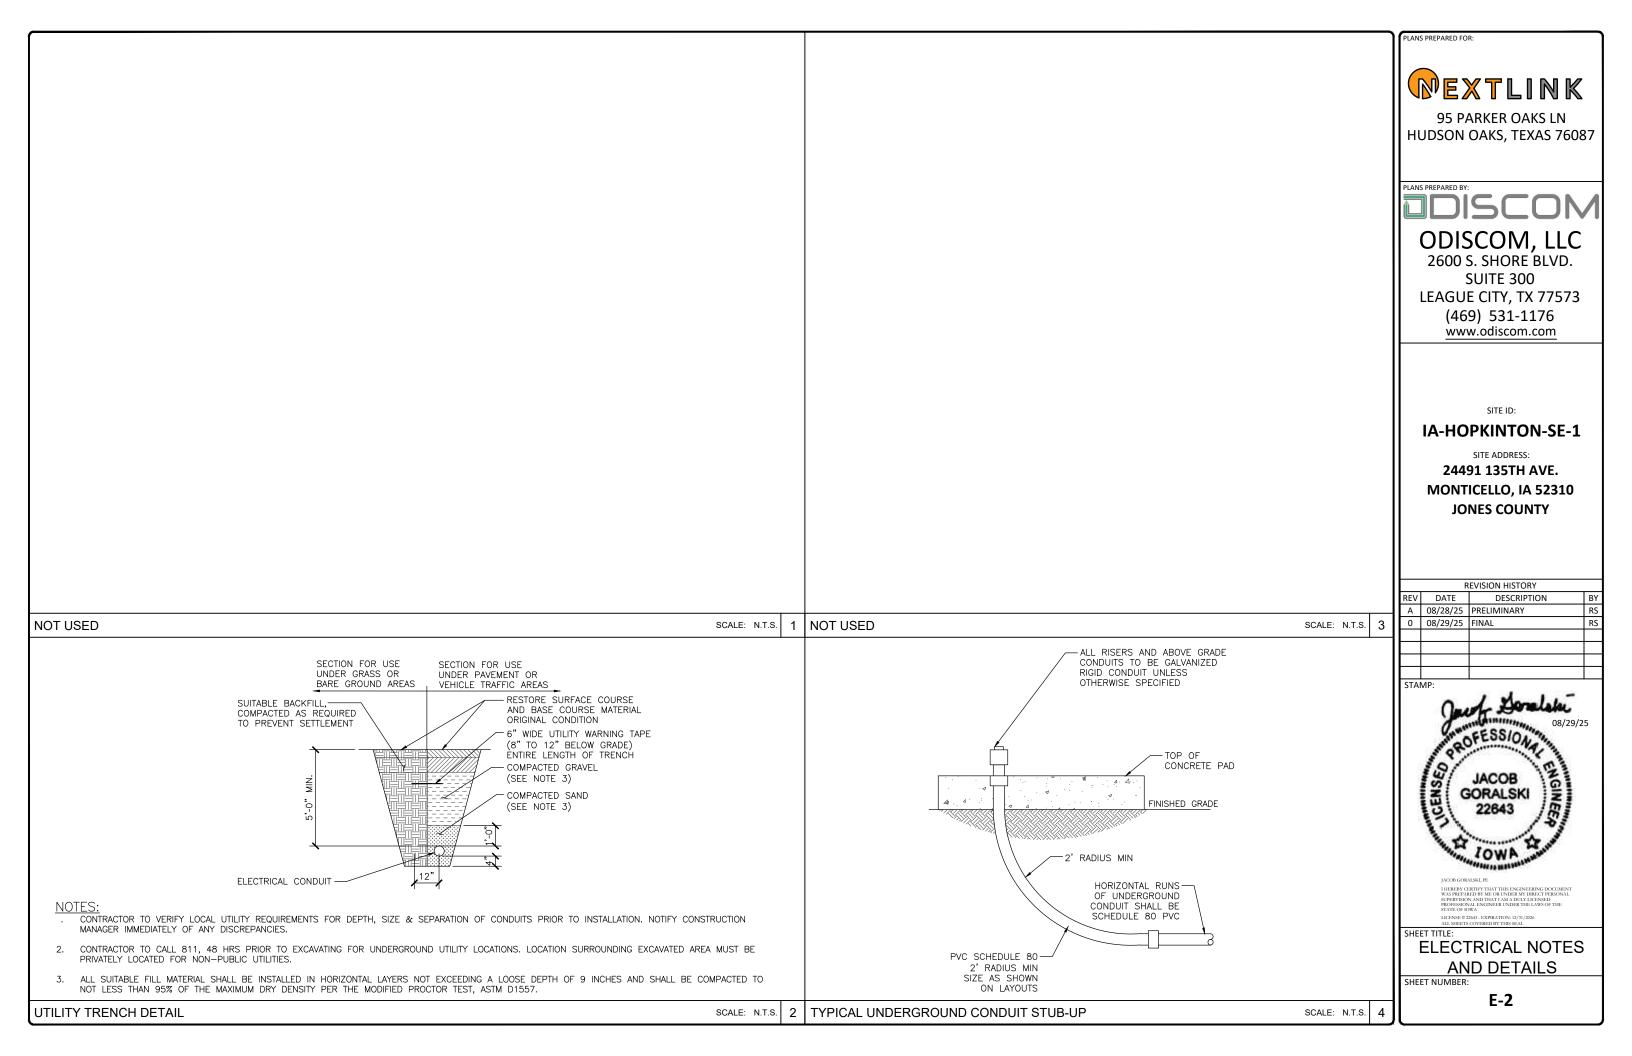
LICENSE # 22643 - EXPIRATION: 12/31/2026


SHEET TITLE:

ELECTRICAL PLAN

SHEET NUMBER:

E-1



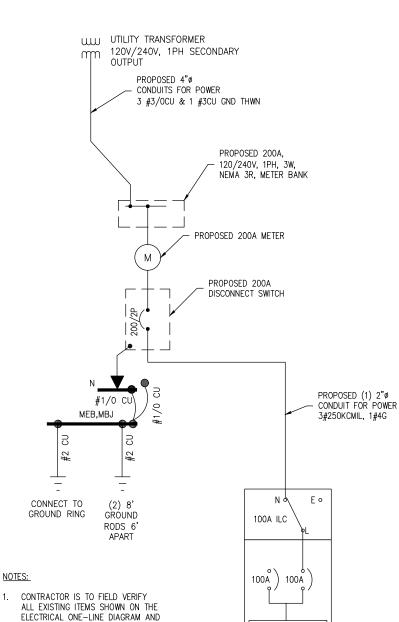

NOTIFY THE ENGINEER OF ANY

2. ALL NEW CONDUCTOR WIRE TO BE

THWN-2, THW-2, RHW-2, OR XHHW-2 WIRE UNLESS NOTED

3. ALL GROUNDING AND BONDING TO

BE PER THE RECOGNIZED EDITION

OF THE NATIONAL ELECTRIC CODE

INSTALLED SHALL BE COPPER. ALL WIRE LARGER THAN #10 SHALL BE

DISCREPANCIES.

OTHERWISE.

(NEC)

ELECTRICAL MATERIAL AND EQUIPMENT NO ELECTRICAL MATERIALS, APPARATUS, DEVICES, APPLIANCES, FIXTURES, OR EQUIPMENT SHALL BE SOLD OR INSTALLED IN THE CITY UNLESS THEY ARE IN CONFORMANCE WITH THE PROVISIONS OF THIS CODE, THE LAWS OF THE STATE OF IOWA AND ANY APPLICABLE RULES AND REGULATIONS ISSUED UNDER THE AUTHORITY OF THE STATE STATUTES. THE MAKER'S NAME, TRADEMARK, OR OTHER IDENTIFICATION SYMBOL SHALL BE PLACED ON ALL ELECTRICAL MATERIALS, APPARATUS, DEVICES, APPLIANCES, FIXTURES, AND EQUIPMENT USED OR INSTALLED UNDER THE PROVISIONS OF THIS CODE. ALL ELECTRICAL MATERIALS AND EQUIPMENT SHALL BE LISTED AND LABELED FOR THE INTENDED USE AND SHALL BE INCLUDED IN A LIST PUBLISHED BY AN APPROVED AGENCY.

PROPOSED PANEL "F

100A. 120/240V

1ø. 3W. 30A MCB. (6) CIRCUIT

NEMA 3R

#2


CONNECT TO GROUND RING

- CONDUCTOR SIZES AND DISTANCES HAVE BEEN SIZED FOR 3% MAX VOLTAGE DROP (TOTAL SYSTEM VOLTAGE DROP ON BOTH FEEDERS AND BRANCH CIRCUITS TO THE FARTHEST DEMAND
- RISING ABOVE GRADE. ALL BENDS SHALL HAVE A MINIMUM

24" RADIUS, ALL FITTINGS SHALL BE SUITABLE FOR USE WITH THREADED RIGID CONDUIT, VERIFY CONDUIT TYPE WITH LOCAL CONSTRUCTION MANAGER AND ADJUST IF NECESSARY. ALL CONDUIT SHALL MEET NEC, STATE, AND LOCAL CODE REQUIREMENTS AS REQUIRED.

- ALL EQUIPMENT SHALL BE NEMA 3R RATED.
- ALL EQUIPMENT SHALL BE LIGHTNING PROTECTED IN ACCORDANCE WITH TIA-222-G AND NEXTLINK STANDARDS.
- SHALL NOT EXCEED 5%). BELOW GRADE CONDUIT SHALL BE SCHEDULE 80 PVC. ABOVE GRADE CONDUIT SHALL BE GALVANIZED RIGID CONDUIT. BELOW GRADE PVC CONDUIT SHALL TRANSITION TO GRC PRIOR TO




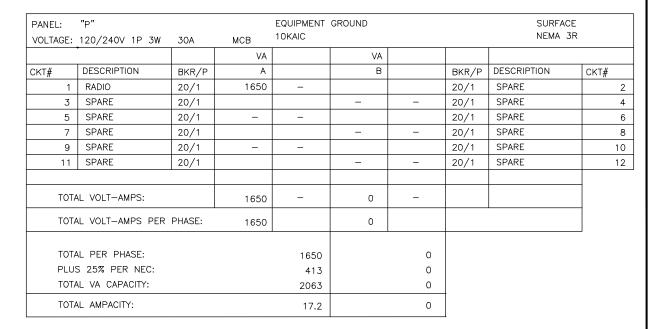

PANEL P SCHEDULE

120/240V 1P 3W	QTY	VA/SF OR VA/UNIT	TOTAL VA	NEC DEMAND	TOTAL NEC VA	AMPERES,	/PHASE B
NEW LOAD:	QII	77 9 3 1 1 1					
RADIO	1	1650	1650	125%	2063	17.2	
TOTAL NEW LOAD:			1650		2063	17.2	

LOAD ANALYSIS

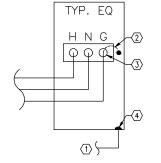

KEYED NOTES:

- 1 BOND ENCLOSURE TO GROUND RING PER NATIONAL ELECTRICAL CODE, REFER TO GROUNDING PLANS.
- \bigcirc BONDING JUMPER TO ENCLOSURE SHALL NOT
- $\begin{tabular}{lll} \hline \end{tabular} \begin{tabular}{lll} \hline \end{tabular} \begin{ta$
- 4 EQUIPMENT/ENCLOSURE BOND.

NOTE: THIS DETAIL PERTAINS TO ALL METALLIC EQUIPMENT AND IS SYMBOLIC OF ACTUAL INSTALLATION AND TO BE USED FOR GENERAL GROUNDING REFERENCE ONLY

EQUIPMENT GROUNDING DETAIL

PLANS PREPARED FOR:



95 PARKER OAKS LN **HUDSON OAKS, TEXAS 76087**

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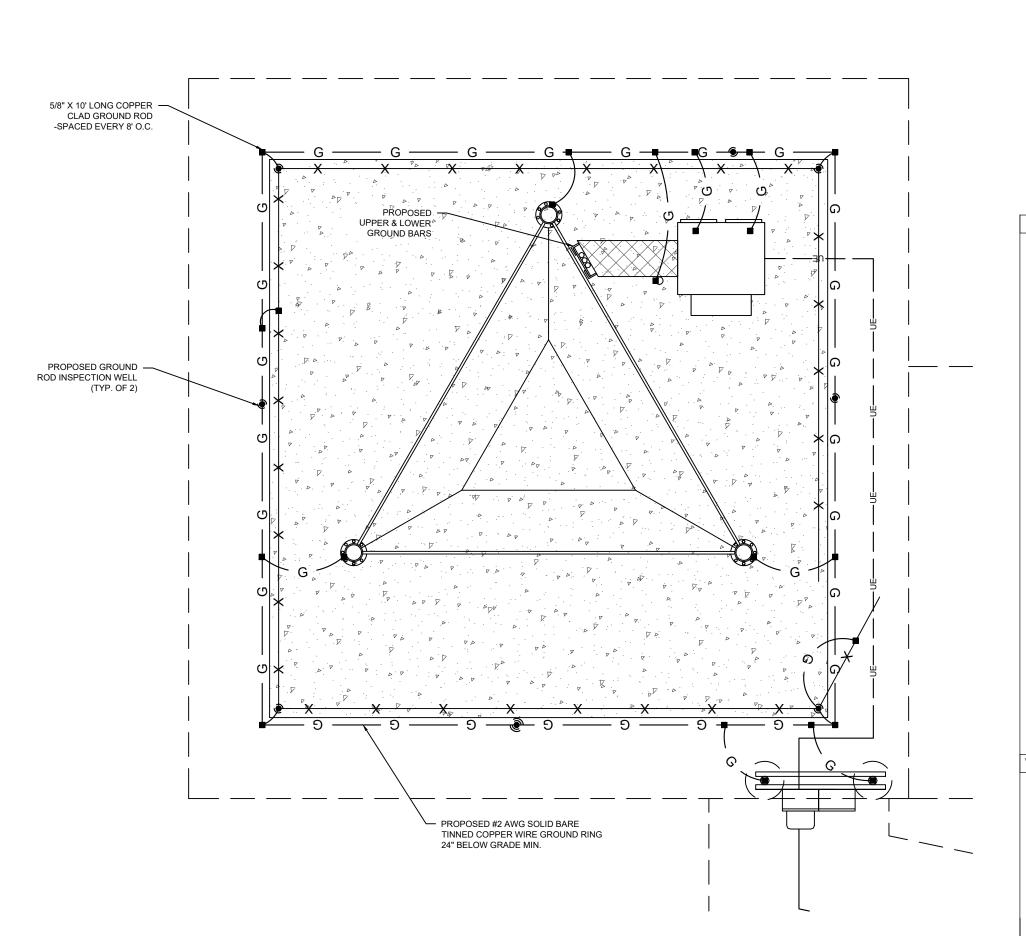


PANEL SCHEDULE & ONELINE

SHEET NUMBER

E-3

ELECTRICAL RISER SCALE: N.T.S.



TYPICAL GROUNDING DIAGRAM

LEGEND

- 10' x 5/8" COPPER CLAD GROUND ROD
- TEST WELL & GROUND ROD

PLANS PREPARED FOR:

PLANS PREPARED BY:

MEXTLINK

95 PARKER OAKS LN

HUDSON OAKS, TEXAS 76087

ODISCOM, LLC 2600 S. SHORE BLVD.

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24491 135TH AVE.

MONTICELLO, IA 52310 JONES COUNTY

REVISION HISTORY

PROFESSION

JACOB

GORALSKI 22643

AWOI

DESCRIPTION

DATE

0 08/29/25 FINAL

STAMP

A 08/28/25 PRELIMINARY

#2 AWG TINNED SOLID BARE CU (GROUND RINGS SHALL BE 30" BELOW GRADE MIN.)


- EXOTHERMIC WELD
- MECHANICAL CONNECTION
- COMPRESSION FITTING
- GROUND BAR

GROUNDING NOTES

- GROUNDING SHALL COMPLY WITH ARTICLE 250 OF THE NATIONAL ELECTRICAL CODE.
- 2. ALL GROUNDING DEVICES SHALL BE U.L. APPROVED OR LISTED FOR THEIR INTENDED
- 3. ALL WIRES SHALL BE AWG THHN/THWN COPPER UNLESS NOTED OTHERWISE.
- 4. GROUNDING CONNECTIONS TO GROUND RODS, GROUNDING RING WIRE AND TOWER BASE SHALL BE EXOTHERMIC ("CADWELLS") UNLESS NOTED OTHERWISE, CLEAN SURFACES TO SHINY METAL, WHEN GROUND ARE CADWELDED TO GALVANIZED SURFACES, SPRAY CADWELD WITH GALVANIZING PAINT.
- GROUNDING CONNECTIONS TO GROUND BARS ARE TO BE TWO -HOLE BRASS MECHANICAL CONNECTORS WITH STAINLESS STEEL HARDWARE (INCLUDING SCREW SET) CLEAN GROUND BAR TO SHINY METAL, AFTER MECHANICAL CONNECTION, THREAT WITH PROTECTIVE ANTIOXIDANT COATING.
- 6. GROUND COAXIAL CABLE SHIELDS AT BOTH ENDS WITH MANUFACTURES GROUNDING
- ROUTE GROUNDING CONDUCTORS THE SHORTEST AND STRAIGHTEST PATH POSSIBLE. BEND GROUNDING LEADS WITH A MINIMUM 12*RADIUS.
- Install #2 and green-insulated stranded wire for above grade grounding and #2 tinned sould copper wire for below grade grounding unless otherwise noted.
- REFER TO GROUNDING PLAN FOR GROUND BAR LOCATIONS, GROUNDING CONNECTIONS SHALL BE EXOTHERMIC ("CADWELDS") TO ANTENNA MOUNTS AND GROUND RING. REMAINING GROUNDING CONNECTIONS SHALL BE COMPRESSION FITTINGS. CONNECTIONS TO GROUND BARS SHALL BE MADE WITH TWO-HOLE LUGS.
- 10. THE GROUND ELECTRODE SYSTEM SHALL CONSIST OF DRIVEN GROUND RODS POSITIONS ACCORDING TO GROUNDING PLAN. THE GROUND RODS SHALL BE 8*X10'-0* COPPER CLAD STEEL INTERCONNECTED WITH #2 TINNED SOLID COPPER WIRE BURIED 36*BELOW GRADE. BURY GROUND RODS A MAXIMUM OF 15
- 11. IF ROCK IS ENCOUNTERED GROUND RODS SHALL BE PLACED AT AN OBLIQUE ANGLE NOT TO EXCEED 45*.
- 12. EXOTHERMIC WELDS SHALL BE MADE IN ACCORDANCE WITH ERICO PRODUCTS BULLETIN $A\!-\!AT$.
- 13. CONSTRUCTION OF GROUND RING AND CONNECTIONS TO EXISTING GROUND RING SYSTEM SHALL BE DOCUMENTED WITH PHOTOGRAPHS PRIOR TO BACKFILLING SITE. PROVIDE PHOTOS TO THE NEXTLINK CONSTRUCTION MANAGER.
- 14. ALL GROUND LEADS EXCEPT THOSE TO THE EQUIPMENT ARE TO BE #2 TINNED SOLID COPPER WIRE. ALL EXTERIOR GROUND BARS TINNED COPPER
- 15. PRIOR TO INSTALLING LUGS ON GROUND WIRES, APPLY THOMAS & BETTS KOPR-SHEILD (TM OF JET LUBE INC.) PRIOR TO BOLTING GROUND WIRE LUGS TO GROUND BARS, APPLY KOPR-SHEILD OR EQUAL.
- 16. ENGAGE AN INDEPENDENT ELECTRICAL TESTING FIRM TO TEST AND VERIFY THAT IMPENDANCE DOES NOT EXCEED FIVE OHMS TO GROUND BY MEANS OF "FALL OF POTENTIAL TEST". TEST SHALL BE WITNESSES BY A NEXTLINK REPRESENTATIVE, AND RECORDED ON THE GROUND RESISTANCE TEST FORM.
- 17. WHERE BARE COPPER GROUND WIRES ARE ROUTED FROM ANY CONNECTION ABOVE GRADE TO GROUND RING, INSTALL WIRE IN **PVC SLEEVE, FROM 1' BELOW GRADE AND SEAL TOP WITH SILICONE MATERIAL.
- PREPARE ALL BONDING SURFACES FOR GROUNDING CONNECTIONS BY REMOVING ALL PAINT AND CORROSION DOWN TO SHINY METAL. FOLLOWING CONNECTION, APPLY APPROPRIATE ANTI— OXIDIZATION PAINT

TYPICAL CADWELD CONNECTIONS

TYPE VBC

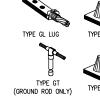

TYPE VS








SHEET TITLE:

GROUNDING PLAN


G-1

SCALE: 3/8"=1"

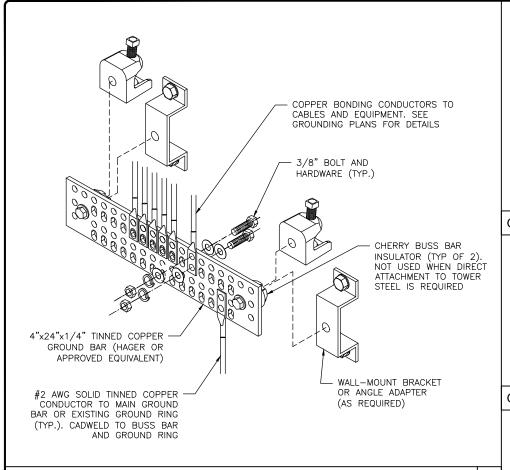


GROUND BAR DETAIL


CADWELD CONNECTION TYPES

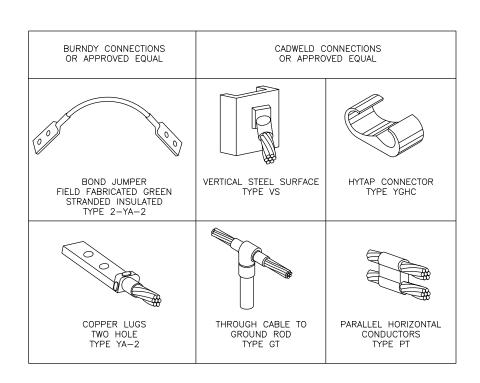

SCALE: N.T.S.

SCALE: N.T.S.

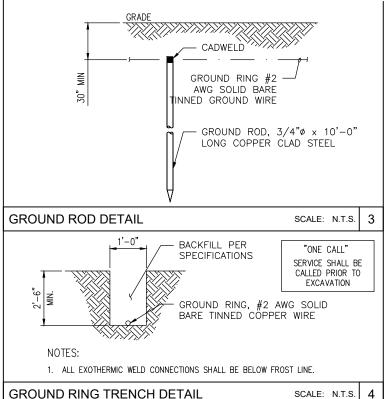


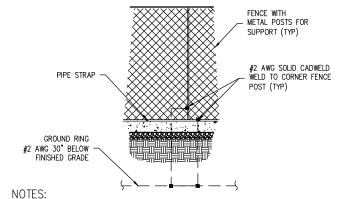


1. THE #2 AWG, FROM THE RING GROUND SHALL BE EXOTHERMIC WELDED TO THE POST, ABOVE GRADE.

2. FOR ABOVE GRADE GROUND WIRE TO GROUND PENETRATION

3. VERTICAL POST SHALL BE BONDED TO THE RING AT EACH CORNER AND AT EACH GATE POST. AS A MINIMUM, ONE VERTICAL POST SHALL BE BONDED TO THE GROUND RING IN EVERY 100 FOOT.

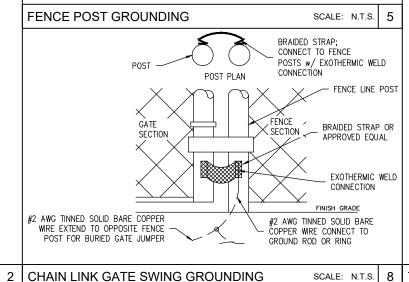


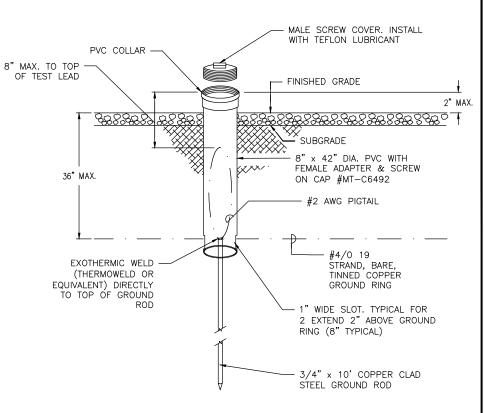

INSPECTION WELL DETAIL

NOTE:

EACH GROUND LEAD IS TO HAVE AN INDEPENDENT SWEPT CONNECTION FROM THE TOWER LEG TO THE GROUND RING

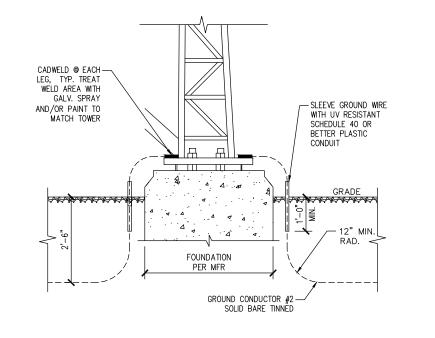

PLANS PREPARED FOR:



95 PARKER OAKS LN **HUDSON OAKS, TEXAS 76087**

ODISCOM, LLC 2600 S. SHORE BLVD. **SUITE 300** LEAGUE CITY, TX 77573 (469) 531-1176

www.odiscom.com

SITE ID:

IA-HOPKINTON-SE-1

SITE ADDRESS:

24491 135TH AVE. **MONTICELLO, IA 52310 JONES COUNTY**

	R	EVISION HISTORY	
REV	DATE	DESCRIPTION	BY
Α	08/28/25	PRELIMINARY	RS
0	08/29/25	FINAL	RS

STAMP:

SCALE: N.T.S. 1



LICENSE # 22643 - EXPIRATION: 12/31/2026

SHEET TITLE:

GROUNDING DETAILS

SHEET NUMBER:

SCALE: N.T.S.

G-2

CHAIN LINK GATE SWING GROUNDING

SCALE: N.T.S.

8

TOWER BASE GROUNDING



TOWER SITE LEASE AGREEMENT AND ACCESS EASEMENT

This Tower Site Lease Agreement and Access Easement ("<u>Agreement</u>") is made to be effective July 30, 2025 ("<u>Effective Date</u>"), by the Mark, Jason, Deanne, Jamie Hasler ("<u>Landlord</u>"), AMG Iowa ISP, LLC, a Iowa limited liability company. d/b/a Nextlink Internet ("<u>Nextlink</u>").

For good and valuable consideration, the parties hereto agree as follows:

- 1. Leased Premises and Access Easement. Named landlord is the owner of certain property located in the County of Jones Iowa at 24491 135th Ave Monticello, Iowa 52310 at (42.288627, -91.140768) (approximate tower location). The legal description of certain property is set forth in Exhibit "A" attached hereto. Landlord has not previously leased the property to another person or entity. Subject to the terms and conditions of this agreement, Landlord hereby leases to Nextlink a portion of the Landlords property of 20' x 20' "tower area". Nextlink leases from Landlord the rights to non-exclusively utilize the Landlord's property ("Leased Premises") more particularly described as described in Exhibit "B" attached hereto and is subject to any and all existing easements and other matters of record. Nextlink intends to construct a tower structure along with directional antennas, connecting cables, and appurtenances ("Antenna Facilities") on the leased premises. In addition, Landlord hereby grants Nextlink a non-exclusive access easement approximately twelve (12) feet in width over and across Landlord's property more particularly described in Exhibit "B" from the nearest public road to the "Antenna Facilities" for reasonable ingress and egress, maintenance, repairs, and utilities including electrical service and access. The site location, access easement and the utility services are collectively referred to as the leased premises.
- 2. **Rent.** As consideration for this Agreement, Nextlink shall provide Landlord with (3) Three free internet connections (100 Mbps residential plan or highest advertised wireless residential plan, where and when available.) an annual payment of (\$1000.00) One Thousand Dollars. Installation and required equipment will be provided by Nextlink at no charge. Such services shall commence upon completion and activation of the Antenna Facilities. Service must be within range and have a clear line of site to the Antenna Facilities.
- 3. <u>Governmental Approval Contingency.</u> Nextlink's right to use the leased Premises is expressly contingent upon it obtaining all the certificates, permits, licenses, zoning and other approvals that may be required by any federal, state, or local authority. In the event that any certificate, permit, license or other approval is finally rejected, is cancelled, expires, lapses, or is otherwise withdrawn or terminated by any applicable governmental authority so that Nextlink, in its sole discretion, determines that it will be unable to use the Leased Premises for the Intended Use (defined below), Nextlink shall have the right to terminate this Agreement.

4. Term and Renewals.

<u>Initial Term.</u> The "<u>Initial Term</u>" of this Agreement shall commence on the Effective Date and expire sixty (60) months after the Effective Date; provided, however, Nextlink's Rent obligations shall commence as set forth in Section 2 above.

Renewal. Subject to the terms and conditions of this Agreement, Nextlink shall have the right to extend this Agreement for three (3) sixty (60) month renewal periods (each, a "Renewal Term") commencing on the first day of the month following the expiration date of the Initial Term or prior Renewal Term. This Agreement shall be automatically renewed for each Renewal Term of sixty (60) months unless Nextlink sends written notice of non-renewal to Landlord no later than thirty days (30) prior to the expiration of the Initial Term or prior Renewal Term. Any additional Renewal Terms beyond the second Renewal Term shall require a mutual agreement in writing signed by Landlord and Nextlink.

Tower Site Lease Agreement and Access Easement – Page 1

- Nextlink's Use of Leased Premises. Nextlink shall use the Leased Premises only for the purpose of installing, maintaining, and operating the Antenna Facilities, and related equipment, cabinets and uses incidental thereto for providing radio and wireless telecommunication services which Nextlink is legally authorized to provide to the public (the "Intended Use"). Nextlink shall have the right, at its sole cost and expense, to operate and maintain the Antenna Facilities on the Leased Premises in accordance with good engineering practices and all applicable FCC rules and regulations. Nextlink's installation of all Antenna Facilities shall be done according to plans approved by Landlord, which approval shall not be unreasonably withheld, conditioned or delayed. Any damage to the Leased Premises or Landlord's adjoining property caused by Nextlink or its contractors during installation or operations of the Antenna Facilities shall be repaired by and at Nextlink's expense within thirty (30) days after notification of such damage by Landlord. The Antenna Facilities shall remain the exclusive property of Nextlink throughout the term of this Agreement. Nextlink shall, at its own expense, maintain any equipment on or attached to the Leased Premises in a safe condition, in good repair and in a manner suitable to Landlord so as not to conflict with the use of Landlord's adjoining property. Nextlink, at all times during this Agreement, shall have access to the Leased Premises in order to install, operate, and maintain its Antenna Facilities.
- 6. <u>Insurance and General Liability.</u> Nextlink must maintain "occurrence" form comprehensive general liability coverage during the Initial Term and any Renewal Terms of this Agreement. Such coverage shall include, but not be limited to, bodily injury, property damage-broad form, and personal injury, for the hazards of Premises/Operation, broad form contractual, independent contractors, and products/completed operations. Said coverage must have limits of liability of not less than \$1,000,000 per occurrence, \$2,000,000 aggregate; and property damage of not less than \$1,000,000. These limits may be satisfied by Nextlink's comprehensive general liability coverage or in combination with an umbrella or excess liability policy. Nextlink must keep in force during the Initial Term and any Renewal Terms of this Agreement a policy covering damages to its property at the Leased Premises. The amount of the property insurance shall be sufficient to replace the damaged property, including loss of use, and shall contain ordinance and law coverage.
- 7. **Agreement Termination.** Except as Set forth in Section 3 hereof (for which no notice is required), this Agreement may be terminated by Nextlink upon sixty (60) days written notice to Landlord. In the event that this Agreement is terminated or not renewed, Nextlink shall have one hundred eighty (180) days from the termination or expiration date to remove its Antenna Facilities and related equipment from the Leased Premises and to repair and restore the surface of the Site Location to its prior condition.
- 8. **Disputes and Notices.** Any claim, controversy or dispute arising out of this Agreement that is not resolved within ten (10) days following notice of the dispute, shall be submitted first and promptly to mediation. Each party shall bear its own costs of mediation. If mediation does not result in settlement within forty-five (45) days after the matter was submitted to mediation, venue for any litigation thereafter shall lie in the district courts of the State of IOWA. All notices hereunder must be in writing and shall be deemed validly given if delivered personally or if sent by certified mail, return receipt requested, addressed as follows (or any other address that the party to be notified may have designated to the sender by like notice):

If to Landlord, to: Attn: Mark Hasler If to Nextlink, to: Nextlink Internet

23500 Hwy 151 95 Parker Oaks Ln. Monticello, IA 52310 Hudson Oaks, Texas 76087

ATTN: David Law

- 9. <u>Complete Agreement; Amendments.</u> This Agreement constitutes the entire agreement and understanding of the parties and supersedes all offers, negotiations, and other agreements of any kind. There are no representations or understandings of any kind except as set forth herein. Any modification of or amendment to this Agreement must be in writing and executed by both parties. This Agreement shall be construed in accordance with the laws of the State of IOWA.
- 10. <u>Severability.</u> If any term of this Agreement is found to be void or invalid, such invalidity shall not affect the remaining terms of this Agreement, which shall continue in full force and effect.
- 11. <u>Binding Effect.</u> This Agreement shall run with the Leased Premises. This Agreement shall extend to and bind the heirs, personal representatives, successors and assigns of the parties hereto. Nextlink may file a Memorandum of Lease in the county where the Leased Premises are located.

Tower Site Lease Agreement and Access Easement – Page 2

<u>Binding Effect.</u> This Agreement shall run with the Leased Premises. This Agreement shall extend to and bind the heirs, personal representatives, successors and assigns of the parties hereto. Nextlink may file a Memorandum of Lease in the county where the Leased Premises are located.

- Payment of Utilities. Nextlink shall provide connections for the consumption of electrical and other utilities associated
 with its use of the leased Premises and shall promptly pay all costs associated therewith.
- Priority Customer Service. For immediate service regarding your internet service/connection call 817-752-5558. For contract questions please call (682) 204-5050 or omail towerhost/atteam.nxlink.com messages and Emails will be reviewed Monday Friday 8am-5pm, responses will be returned within 2 business days.

IN WITNESS WHEREOF, the parties hereto have set their hands the day and year first above written.

LANDOWNER: Mark, Jason, Deanne, Jamie Hasler

By Mark Hose

Mark Haster

By Japan Heisler

Jason Hasler

By Deanne Hasles

Deanne Hasler

Dy 1 1

Jamie Hasler

NEXTLINK:

AMG Iowa ISP, LLC, a Iowa limited liability company, d/b/a Nextlink Internet

Ву

David Law - V.P of Field Operations

Exhibit "A"

Legal Description of Landlord's Property

Parcel ID - 0201300003

Alt Id - 058400

Address - 24491 135TH AVE

Owner - HASLER, MARK ETAL

(Deed)

HASLER, JASON (Deed)

HASLER, DEANNE (Deed)

HASLER, MARK J (Deed)

HASLER, JAMIE (Deed)

Acres - 9.75

View: Parcel Report | Soil Report

 Parcel ID
 0201300003
 Alternate ID058400
 Owner AddressHASLER, MARK ETAL

 Sec/Twp/Rng
 01-86-03
 Class
 A
 23500 HWY 151

 Property Address 24491 135TH AVE
 Acreage
 9.75
 MONTICELLO, IA 52310

MONTICELLO

District LOVMO

Brief Tax Description 01 86 03 N 1/4 NE SW

<u>Tower Site Lease Agreement and Access Easement – Page 4</u>

Exhibit "B"

Site Location Description

The Site consists of the telecommunications tower and equipment cabinet to be located in the county of Jones Iowa at 24491 135th Ave Monticello, Iowa 52310 at (42.288627, -91.140768) (approximate tower location). The approximate tower location is indicated by a green square.

Nextlink



<u>Tower Site Lease Agreement and Access Easement – Page 5</u>





<u>Tower Site Lease Agreement and Access Easement – Page 6</u>





<u>Tower Site Lease Agreement and Access Easement – Page 7</u>



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Title IA-HOPKINTON-SE-SR-1

File name IA-HOPKINTON-SE-1.docx

Document ID 26cab2ea3a969fb0d0d030be94b6287a0d7328b4

Audit trail date format MM / DD / YYYY

Status • Signed

Document History

7 Sent for signature to Collin Harris

SENT 12:33:58 UTC-5 (charris@team.nxlink.com), Mike Johnson

(mjohnson@team.nxlink.com) and David Law

(dlaw@team.nxlink.com) from smcintyre@team.nxlink.com

IP: 107.178.5.97

ON 13 / 2025 Viewed by Collin Harris (charris@team.nxlink.com)

VIEWED 13:05:55 UTC-5 IP: 107.178.5.97

SIGNED 13:06:52 UTC-5 IP: 107.178.5.97

O8 / 14 / 2025 Viewed by Mike Johnson (mjohnson@team.nxlink.com)

VIEWED 11:07:33 UTC-5 IP: 107.178.5.97

SIGNED 11:07:53 UTC-5 IP: 107.178.5.97



Title IA-HOPKINTON-SE-SR-1

File name IA-HOPKINTON-SE-1.docx

Document ID 26cab2ea3a969fb0d0d030be94b6287a0d7328b4

Audit trail date format MM / DD / YYYY

Status • Signed

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O8 / 14 / 2025 Viewed by David Law (dlaw@team.nxlink.com)

VIEWED 11:19:50 UTC-5 IP: 107.178.5.97

% Signed by David Law (dlaw@team.nxlink.com)

SIGNED 11:25:29 UTC-5 IP: 107.178.5.97

7 08 / 14 / 2025 The document has been completed.

COMPLETED 11:25:29 UTC-5

Jones County Land Use Rm 113 Courthouse, 500 W Main St.

Anamosa, Iowa 52205

Phone: 319-462-2282 Fax: 319-462-5815 Email: landuse@jonescountyiowa.gov Website: <u>www.jonescountyiowa.gov</u>



Written Report of the Jones County Land Use Administrator Special Permitted Use

Application from:	Mark, Jason, Deanne, and Jamie Hasler	
	AMG Technology Investment Group, dba Nextlink	
	applicant	
For property located at:	24491 135 th Ave., Monitcello	
Brief legal descriptions:	N 1/4 NE 1/4 SW 1/4	
Parcel number:	02-01-300-003	
Parcel size:	9.75 acres	
Current Zoning District:	A-Agricultural	
Purpose:	A proposed 155' Nextlink Communications tower	
Date application received:	September 19, 2025	
Applicable fee:	\$250 paid on September 19, 2025	
Notice published: (Article XXV-Section 5)	Week of October 13, 2025 (11-13 days notice provided; 5-20 days required)	
Adjacent property owners notified by	October 2025	
certified mail: (Article XXV-Section 5)		
Report mailed to Planning and	October 15, 2025	
Zoning Commission:(Article XXV-Section 7)		
Report mailed to Applicant: (Article XXV-Section 7)	October 15, 2025	

Copy of application, statement of intent and parcel map attached.

See pages 2 and 3 for report.

Page 2: Mark, Jason, Deanne, and Jamie Hasler <u>Applicant: AMG Technology Investment Group, dba Nextlink</u> Board of Adjustment meeting date: October 21, 2025 at 4:00 p.m.

Report of the Jones County Land Use Administrator (Article XXV-Section 7)

Written			
Report Provided	Consultation by the following, if necessary (Article XXV-Section 7):		
Flovided	Jones County Engineer- Derek Snead		
Comments:	I have reviewed the Special Permitted Use Application submitted by the Haslers in Section 1 of Lovell Township. My comments are as follows: • Jones County has established rules for control of access to secondary roads. This policy was developed to formalize Jones County's requirements for the location and establishment of driveways, field accesses and farm entrances requested by county property owners. If a new access will be constructed or if there are any proposed changes to an existing property access, the property owner must file an 'Application for Access' with the Jones County Secondary Road Department prior to commencing any access construction. • Jones County has established an ordinance to ensure uniform building and structural alterations along County public secondary road rights-of-way that will protect and preserve the highway corridor. If a property owner desires to build a structure or alter an existing structure that is within thirty feet of the secondary road right-of-way, then a variance request must be filed with the County Engineer's Office before any construction may commence. • Any work that may necessitate work (ditching, driveway resurfacing, etc.) within the County road right-of-way must first obtain an Application for Alteration of Public Right-of-Way before commencing with construction. If the applicant has any questions on any of the above conditions, please contact myself for more information and guidance.		
	Jones County District Soil Conservationist - Addie Manternach		
Comments:	No comments received.		
	Jones County Environmental Health – Lisa Bogran		
Comments:	We saw nothing in the plans for any need for environmental permits through our office.		
	Executive Director of the Jones County Conservation Board – Brad Mormann		
Comments:	No comments received.		
	Flood Plain Coordinator – Brenda Leonard		
Comments:	This location is not in a flood plain.		
	E-911 Coordinator – Gary Schwab		
Comments:	In review of the above stated application, the Jones County 911 office finds that there are no conflicts, pursuant to Chapter 3, Uniform Rural Address System to Title IV Streets, Roads, Public Ways and Transportation, as part of the Jones County Code of Ordinances. I do recommend a 911 address off of 135th Ave as the electric service company will require a physical address before providing services.		

Page 3: Owners: Mark, Jason, Deanne, and Jamie Hasler Applicant: AMG Technology Investment Group, dba Nextlink Board of Adjustment meeting date: October 21, 2025 at 4:00 p.m.

Communication Tower Checklist				
Is co-location on another tower a possibility? Section 4.A.				
No	According to the application, a co-location was not possible due to the closest tower is about 2 miles away from our current location and we were specific with this location			
	to meet RDOF/CAF requirements.			
Yes	Is the proposed tower located in A, C1, C2, I1 or I2? Section 4.C.			
Yes	If the tower is free-standing, is the lot size at least 20,000 sq. feet? Section 5.A. This is a self-support tower and is located on a parcel that is 9.75 acres.			
Yes	Is the tower less than 350 feet? Section 5. B.			
Yes	Does the proposed tower meet the setbacks within the ordinance? Section 5. C. All other towers — 100 ft. from property line or a distance equal to the height of the tower, whichever is greater. According to the application, the tower has a 150' radius set back. With this set back it does appear to go into the roadway, and across property lines. The property owners do own the adjacent parcel.			
No	Is the tower within 200 feet of an existing or proposed residence? Section 6.A.			
Review	Will the tower be painted aviation orange and white and equipped with red night time beacon lighting only? Section 6. B. After speaking with Nextlink representative Megan Croop, she advised they do not paint their towers, or use any lighting on the towers unless required by the FAA.			
No	Will the tower have any signage or other advertising? Section 6. C.			
No	Will the proposed interfere with existing or proposed public safety communications? Section 6. D.			
Yes	Is the tower outside of a flood plain? Section 6. E.			
Review	Has the application been reviewed by the Jones County Historic Preservation Commission? Section 6. F The Land Use Administrator has sent the application for review by the Jones County Historical Society.			
Yes	Has all tower site plan requirements been met as listed in Section 7.?			
Yes	Has the applicant provided written data regarding ownership of the tower, including FCC Antenna Structure Registration Number, management of the tower (which includes three contacts) and the name of the leasor(s) and lease (s). According to the application documents the FAA and FCC state that registration of this tower falls within their guidelines and does not need to be registered.			

Whitney Amos	 Date	
Land Use Administrator		